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Legend

Revision		 	Appd.	MM.DD.
Issued		Ву	Appd.	MM.DD.
File Name:	FDA Dwn.	PJM Chkd.	PJM Dsgn.	05.21.1 MM.DD.

Client/Project


Permit-Seal

FLATROCK DAM OVERLAY ON 1921 TOPO FLATROCK, MICHIGAN

Title

BORINGS TO ROCK (REFERENCE DRAWING)

(1141 11141	NOL DIVAVVINO)	
Project No. 2075092501	Scale NONE	
Drawing No.	Sheet	Revision
C-100	1 of 2	

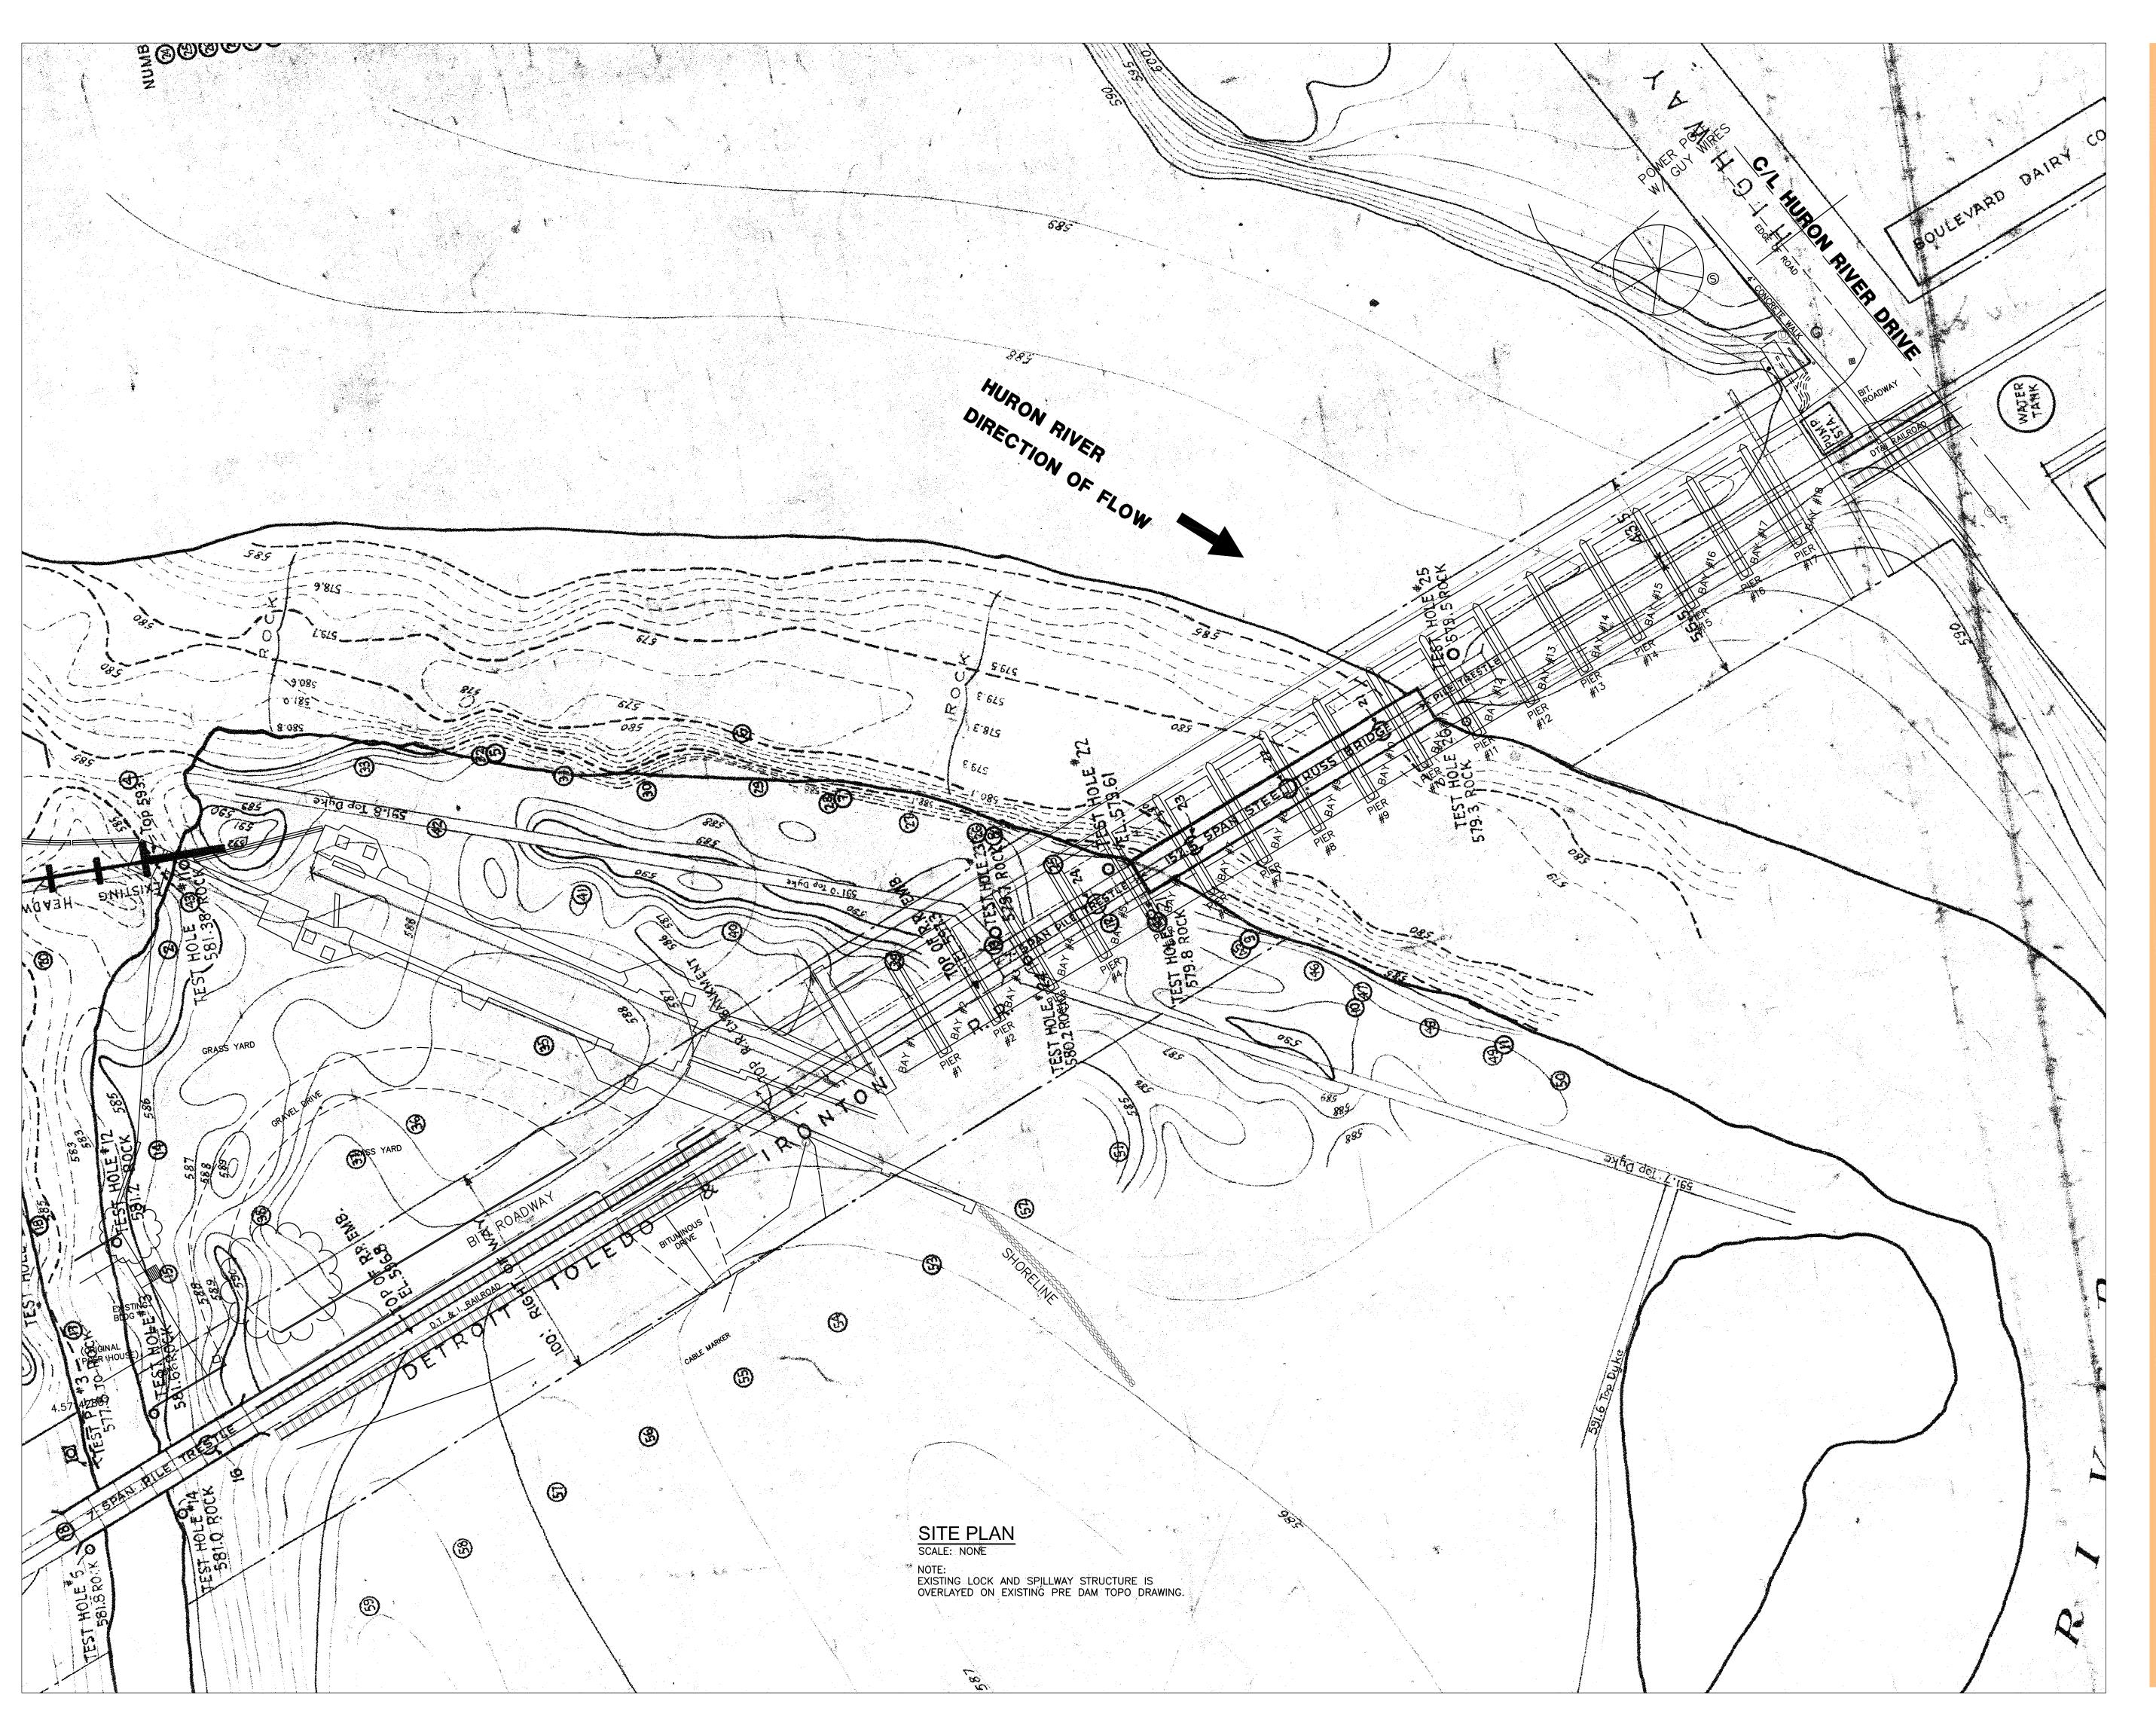



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Client/Project


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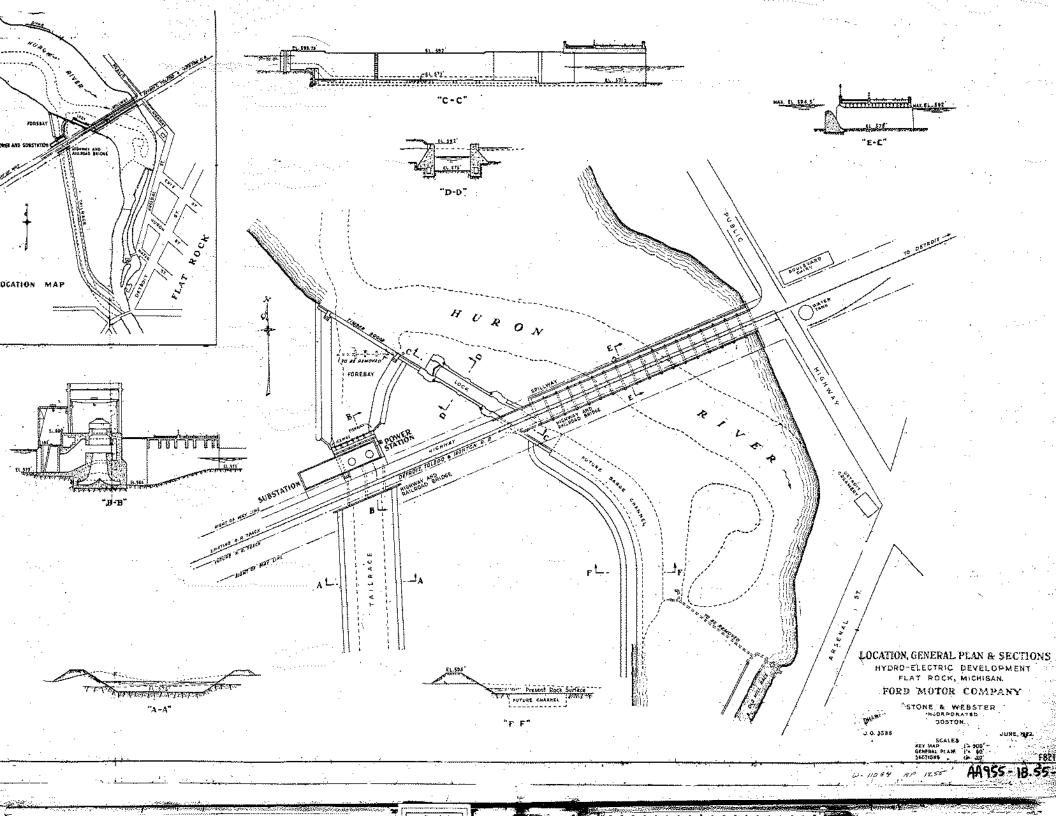
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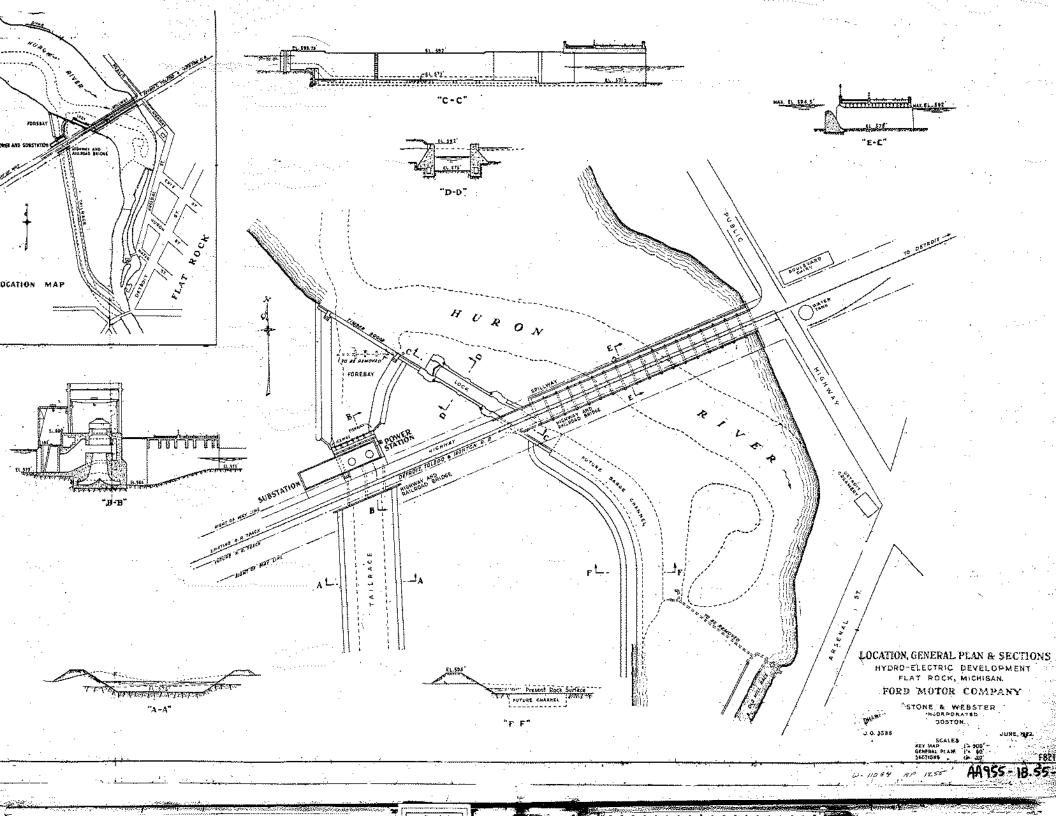
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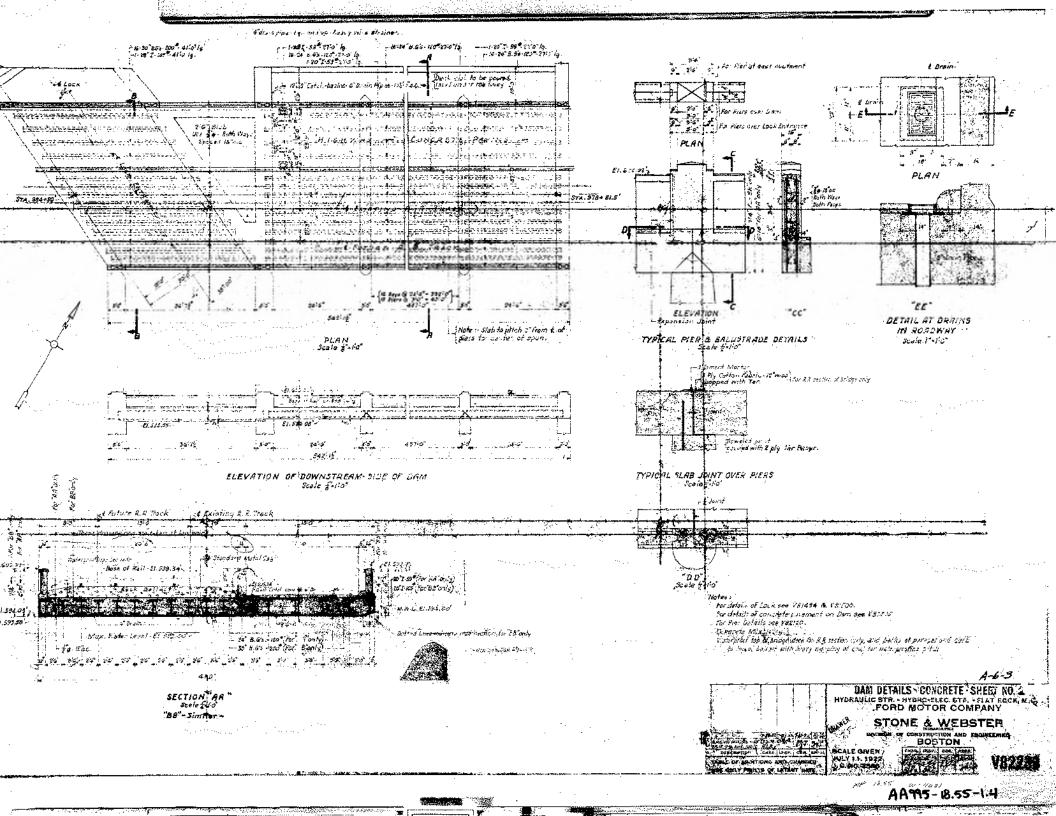
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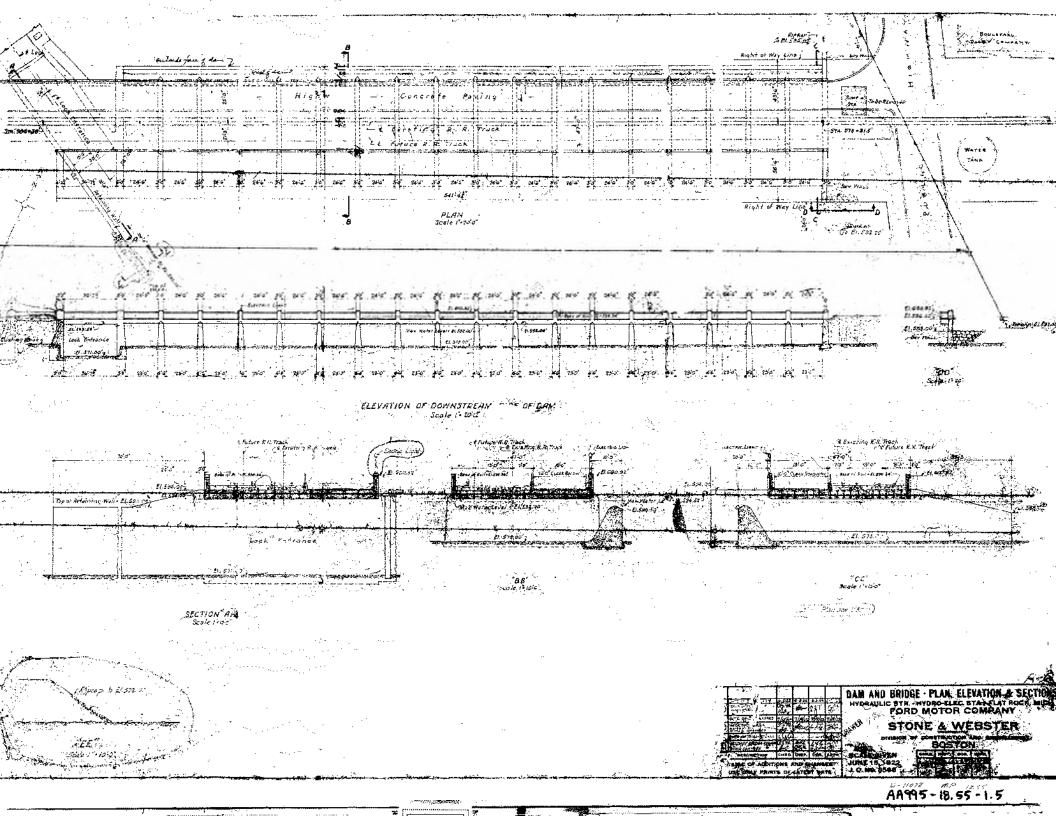
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Project No.	Scale	
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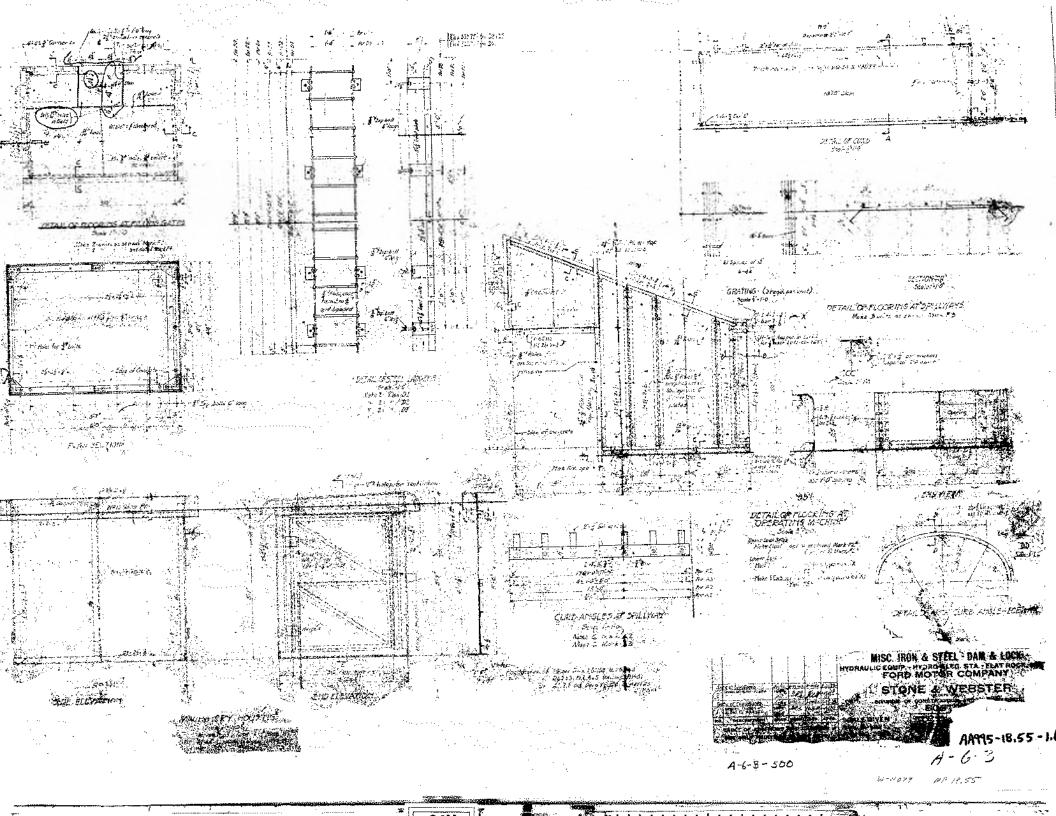













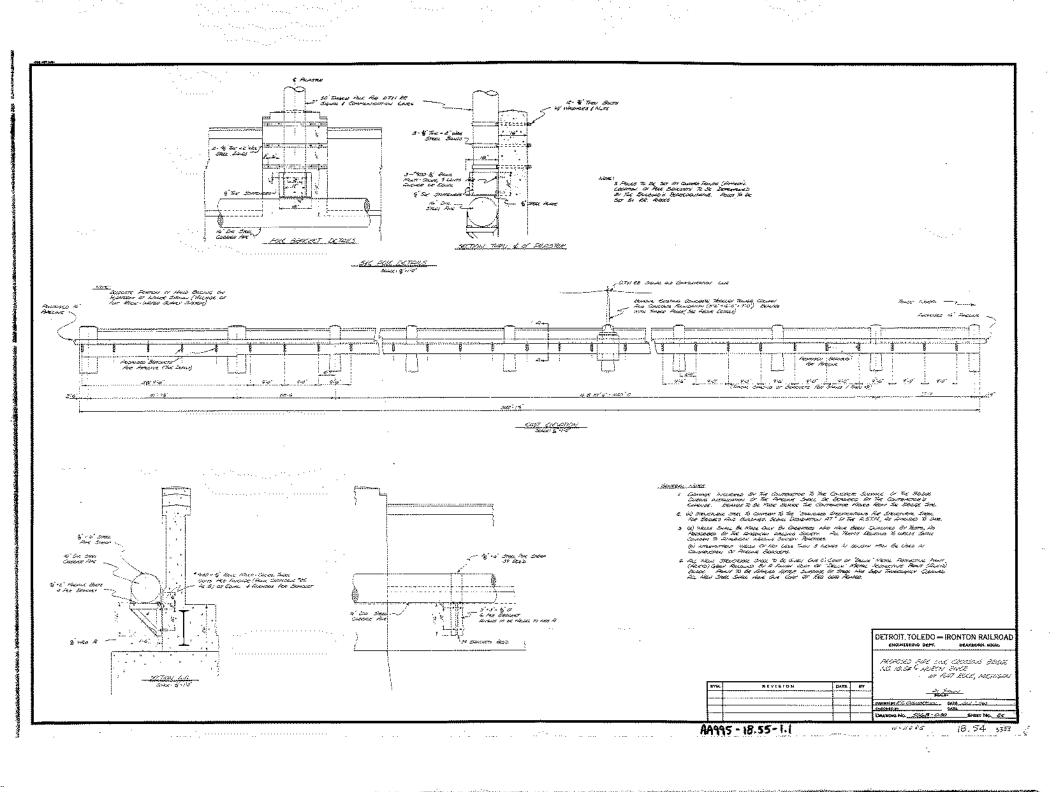

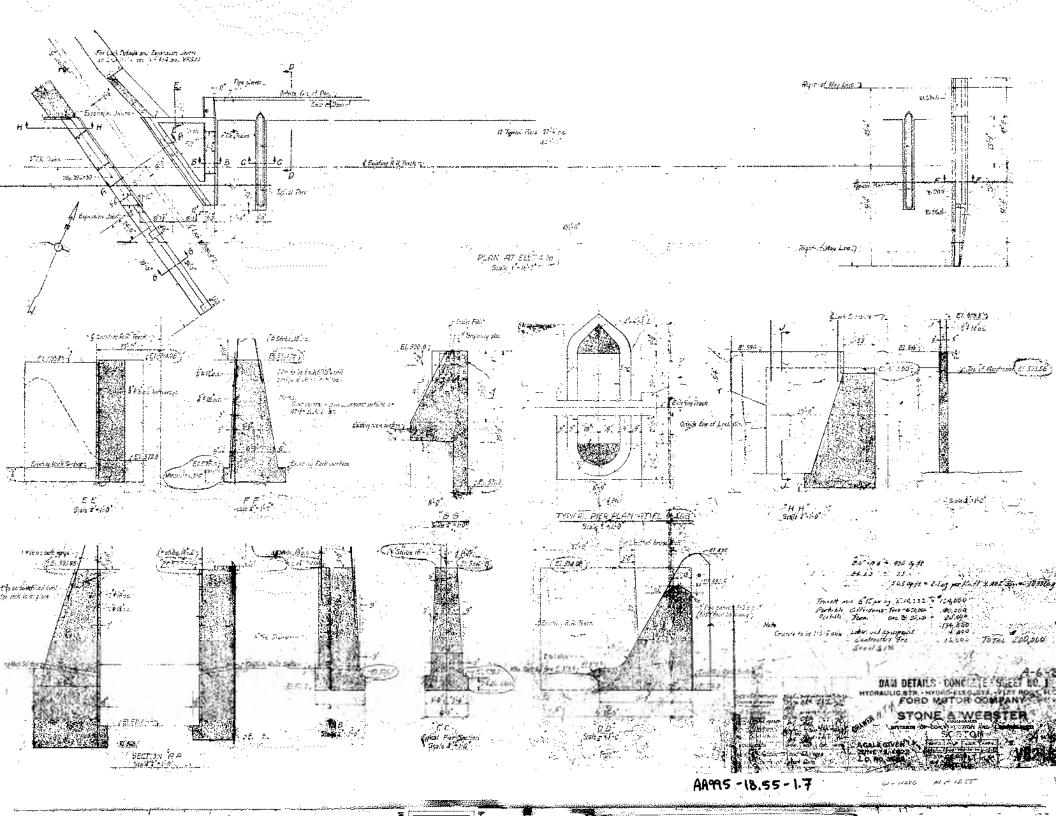

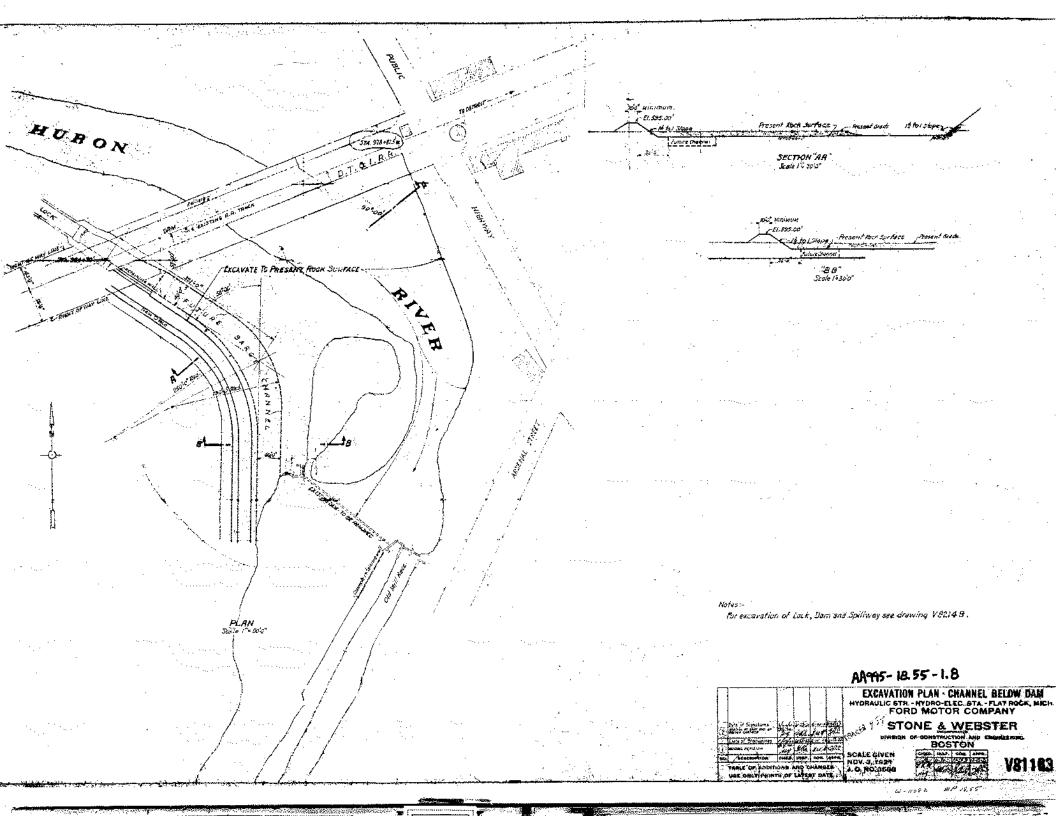


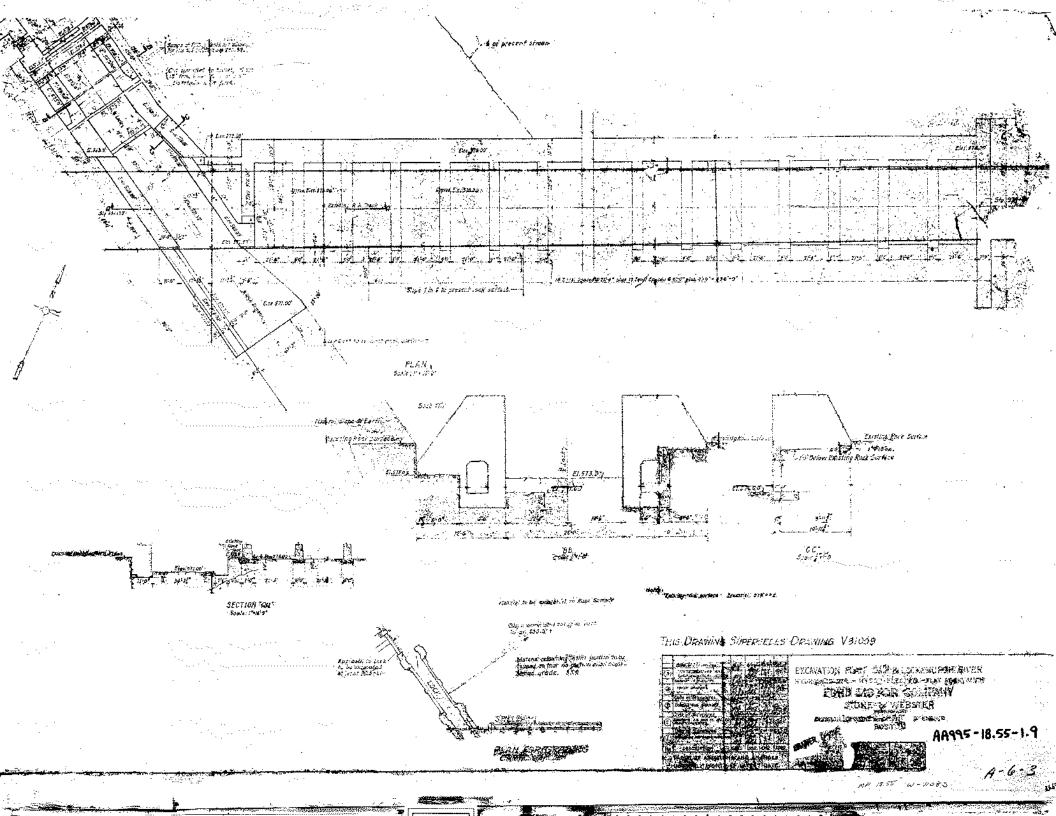

HURON CLINTON METROPOLITAN AUTHORITY

PLANS FOR

FLAT ROCK DAM 2008 REPAIRS

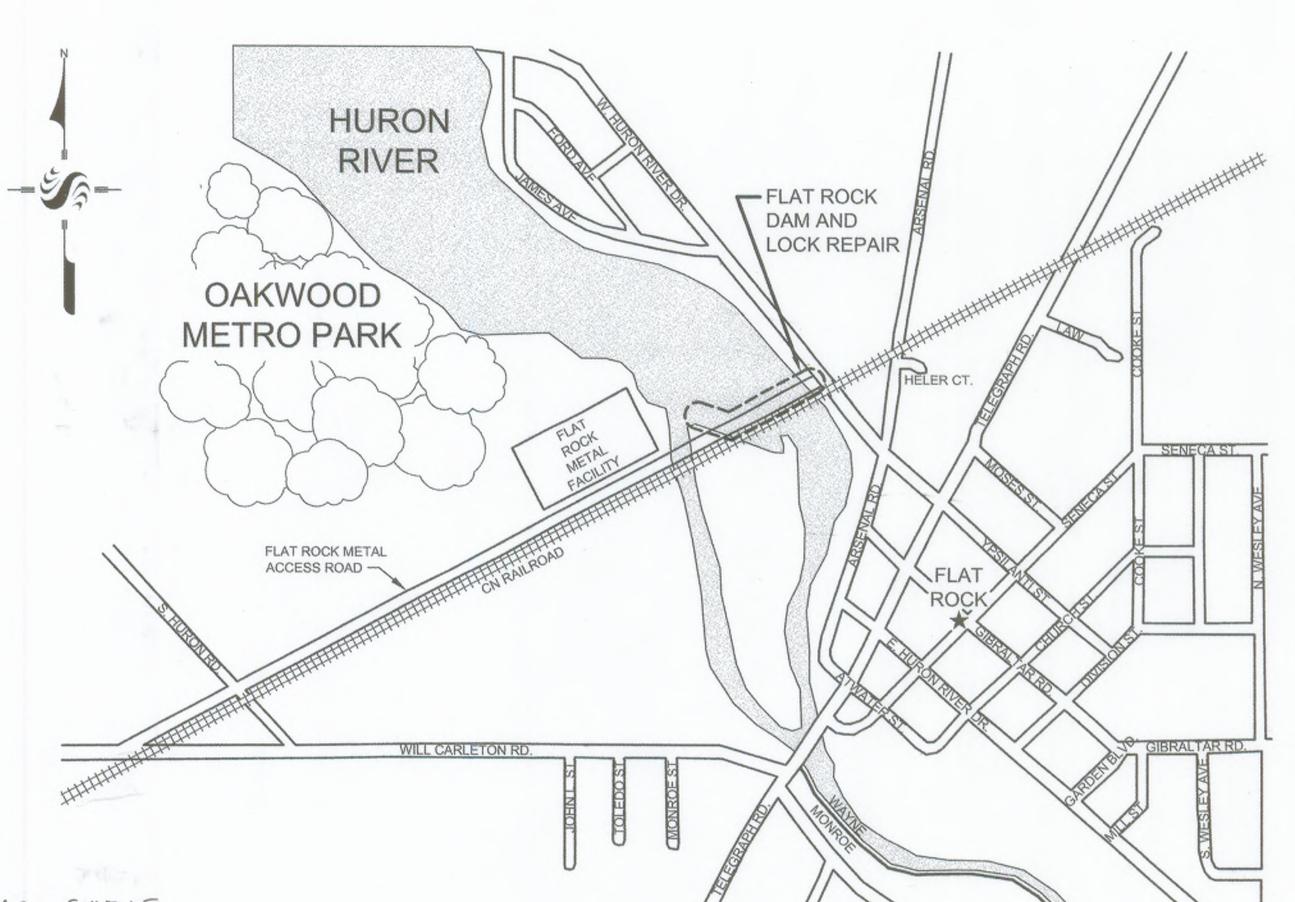

MAY 2008

A.B.C-001 - OVERALL SITE PLAN

DRAWING INDEX:

A.B. C-002 — SOIL EROSION CONTROL AND MISC. DETAILS

A.B. C-101 — RIGHT SIDE, LOCK DEMOLITION PLAN

AB. C-102 - RIGHT SIDE, LOCK DEMOLITION DETAILS

A.B. C-103 — RIGHT SIDE RECONSTRUCTION PLAN

A.B. C-201 — LEFT SIDE, DEMOLITION PLAN

A.B. C-202 - LEFT SIDE, RECONSTRUCTION PLAN

A.B. C-301 — RECONSTRUCTION DETAILS AND SECTIONS I

A.B. C-302 — RECONSTRUCTION DETAILS AND SECTIONS II

REFERENCE DRAWINGS (1922 STONE AND WEBSTER)

C-491 - LOCATION, GENERAL PLAN AND SECTIONS

C-402 - EXCAVATION PLAN

C-403 - PLAN, ELEVATION AND SECTIONS

C-404 - DETAILS

C-405 - DETAILS

C-406 - BORINGS TO ROCK

MDOT STANDARD DETAILS NOT INCLUDED IN THESE PRINTS (R-60-F, R-66-E AND R-67-E)

SCHEDULE ESTIMATED SCHEDULE:

1. PRIOR TO BEGINNING CONSTRUCTION, THE CONTRACTOR SHALL NOTIFY MDNR FISHERIES DIVISION (SEE CONTACT INFO, THIS SHEET) OF PROPOSED SCHEDULE. NO IN-WATER CONSTRUCTION ACTIVITIES WILL BE PERMITTED FROM OCTOBER 30 THROUGH JUNE 30, INCLUSIVE.

2. COFFERDAM INSTALLATION AND REMOVAL SHALL BE AS PER IN-WATER GENERAL SEQUENCE OF CONSTRUCTION (SHEET C.001).

START: JULY 1, 2008 AUGUST ZOOB

JULY, 2008

DELIVER EQUIPMENT TO SITE

INSTALL SILT FENCE, FISH LADDER COVER, MUD TRACKING DEVICE AND

- TEMPORARY RIP RAP, ALL LOCATIONS. SETUP TEMPORARY FENCE, ALL LOCATIONS.
- DEMOLISH OLD FENCE.
- INSTALL LOCK COFFERDAM AND DEWATER.
- EXCAVATE ALONG LOCK WALL
- DEMOLISH OLD CONCRETE AND LOCK STRUCTURE EQUIPMENT. RECONSTRUCT CONCRETE AND FILL VOIDS IN LOCK WALLS.
- REMOVE LOCK COFFERDAMS.
- BACKFILL ALONG LOCK WALL.

AUGUST, 2008 -

(REPAIR STEPS SHALL INCLUDE TURBIDITY CURTAINS, COFFERDAMS AND DEWATERING AS REQUIRED PER NOTES ON C.001)

- MAKE REPAIRS TO STRUCTURES. PLACE TREMIE CONCRETE IN BAYS #1, #2-AND #3, # 4 A.B.
- MAKE REPAIRS TO STRUCTURES AND REPLACE TREMIE
- -CONCRETE, BAYS #4, #5 AND #6. PLACE TREMIE CONCRETE BAYS #7, #8 AND #9.

OPENED FISH LADDER BY ILOS, OF AS DIRECTED BY DNR (ONR WANTED, COFFERDAM TO REMAIN IN PLACE UNTIL THEY DID

SOME REPAIRS.

CONTRACTOR STOPPED WORK IN DECEMBER, DUE TO TEMP. RESTRICTIONS ON MAT LS. RIGHT SIDE REPARS DONE + TREPMINE IN BAYS # 1-#4,

START UP AFTER WINTER, JULY 2009.

AREA MAP NO SCALE

- MAKE REPAIRS AND PLACE TREMIE CONCRETE BAYS #10, #16 AND #17
- INSTALL TEMPORARY GUARDRAIL AT LEFT SIDE AND REMOVE OLD GUARDRAIL AT GAS LINE.
- INSTALL COFFERDAM ON LEFT BANK.
- REMOVE OLD REVETMENT BLOCKS.
- EXCAVATE ALONG LEFT UPSTREAM WALL
- DEMOLISH OLD CONCRETE AND MAKE REPAIRS.
- BACKFILL ALONG LEFT WALL
- CONSTRUCT NEW REVETMENT WALL. REMOVE LEFT COFFERDAM.
- INSTALL NEW PERMANENT GUARDRAIL AT GAS LINE AND REMOVE TEMPORARY GUARDRAIL.

TREMIE CONC. IN BAYS #5-#8.


OCTOBER, 2008

· REMOVE MAJOR EQUIPMENT FROM SITE.

- REMOVE TEMPORARY FENCING AND MUD TRACKING DEVICE.
- DO FINE-GRADING TO SITE. INSTALL PERMANENT FENCING.
- TRAP AND RELOCATE WOODCHUCKS. (DONE BEFORE BRETAK)
- ESTABLISH PERMANENT GROUND COVER.
- REMOVE SILT FENCING AND FISH LADDER COVER.

FINISH: OCTOBER 15, 2008-DECEMBER, 2009

PLAUED LEFT COFFEEDAM & REMOVED LEFT SIDE REVETMENT. +

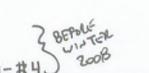



Project Contacts

Utilities and Holders of Rights of Way

- Ameritech
- AT & T Peter Wlotkowski
- 800-437-3497 734-721-8835
- Comcast
- · DTE Gas: Jim Barnette
- Doug Miller
- Cell 419-764-3132 Office 734-856-2161
- 419-421-2211
- Don Karn
- 330-233-0496
- Matt Vale 313-292-8850

- 800-482-7161
- 734-523-6888 .
- Buckeye Pipeline
- 734-788-3631
- Electric: 734-397-4321 313-389-7304.
- Kindermorgan (Dome Pipeline Corp)
- Marathon Ashlund Pipeline Company Regulatory/Agency
- Qwest 800-482-7161
- Sunoco

City of Flat Rock

Bruce Hammond Director of Public Works 734-782-2470

 CN Railroad (Flat Rock Subdivision. Mile post 18.55 to 18.65 bridge over Huron River.) Waldemar Wolosiewicz.

Local Industry:

 Flat Rock Metal Greg Zang 734-782-4454

248-452-4989

 Huron Clinton Metropolitan Authority 810-227-2757 Ext 5154

 Huron River Fishermen's Association Ed McCarter

 MDEQ Dam Safety Paul Wessel 517-241-9862

734-262-0120

- MDNR Fisheries Division Jeffrey Braunscheidel 248-359-9048
- US Fish and Wildlife Service (East Lansing Field Office) Barb Hofler 517-351-2555
- Wayne County Watershed Management 734-326-3936
- Wayne County DPS Yolanda Clemens 734-595-6504

PERMITS

MDEQ-INLAND LAKES AND STREAMS DAM SAFETY WAYNE COUNTY SOIL EROSION WAYNE COUNTY WORK WITHIN R.O.W. (HURON RIVER DRIVE) PERMIT/FILE NO. 07-82-0168-P 07-219 R 08-030




STANTEC #2075092501 PREPARED BY:

STANTEC

3959 RESEARCH PARK DRIVE ANN ARBOR, MI 48108 (734) 761-1010

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- DRAINS, LAKES AND PONDS.
- 4. EROSION AND SEDIMENT CONTROL MEASURES ARE TO BE PLACED PRIOR TO, OR AS THE FIRST STEP IN, CONSTRUCTION. SEDIMENT CONTROL PRACTICES SHALL BE APPLIED AS A PERIMETER DEFENSE AGAINST ANY TRANSPORTATION OF SILT OFF THE SITE.
- 5. CONTRACTOR SHALL APPLY TEMPORARY EROSION AND SEDIMENTATION CONTROL AS REQUIRED AND AS DIRECTED IN THESE PLANS. HE SHALL REMOVE TEMPORARY MEASURES AS SOON AS PERMANENT STABILIZATION OF SLOPES, DITCHES AND OTHER EARTH CHANGES HAS BEEN ACCOMPLISHED.
- IMPLEMENTED AND ESTABLISHED BEFORE A CERTIFICATE OF COMPLIANCE IS ISSUED.
- 8. ALL MUD/DIRT TRACKED ONTO EXISTING CITY/COUNTY/STATE ROADS FROM THIS SITE, DUE TO CONSTRUCTION, SHALL BE PROMPTLY REMOVED BY THE CONTRACTOR/BUILDER, ALL MUD/DIRT TRACKED OR SPILLED ONTO PAVED ROADS OR PAVED SURFACES WITHIN THIS SITE SHALL BE PROMPTLY REMOVED BY THE CONTRACTOR/BUILDER.
- 9. DISTURBED AREAS WITHIN PUBLIC RIGHTS-OF-WAY SHALL BE RESTORED WITH 4" TOPSOIL, SEEDED AND MULCHED.
- 10. IF A TEMPORARY SOIL STOCKPILE IS NEEDED, AREA MUST BE SURROUNDED BY 2 ROWS OF CONTINUOUS HAY BALES. LOCATION OF OFFSITE DISPOSAL AREA TO BE DETERMINED. I ROW OF SILT FONCE PER COUNTY SESS OFFICER. A.B.

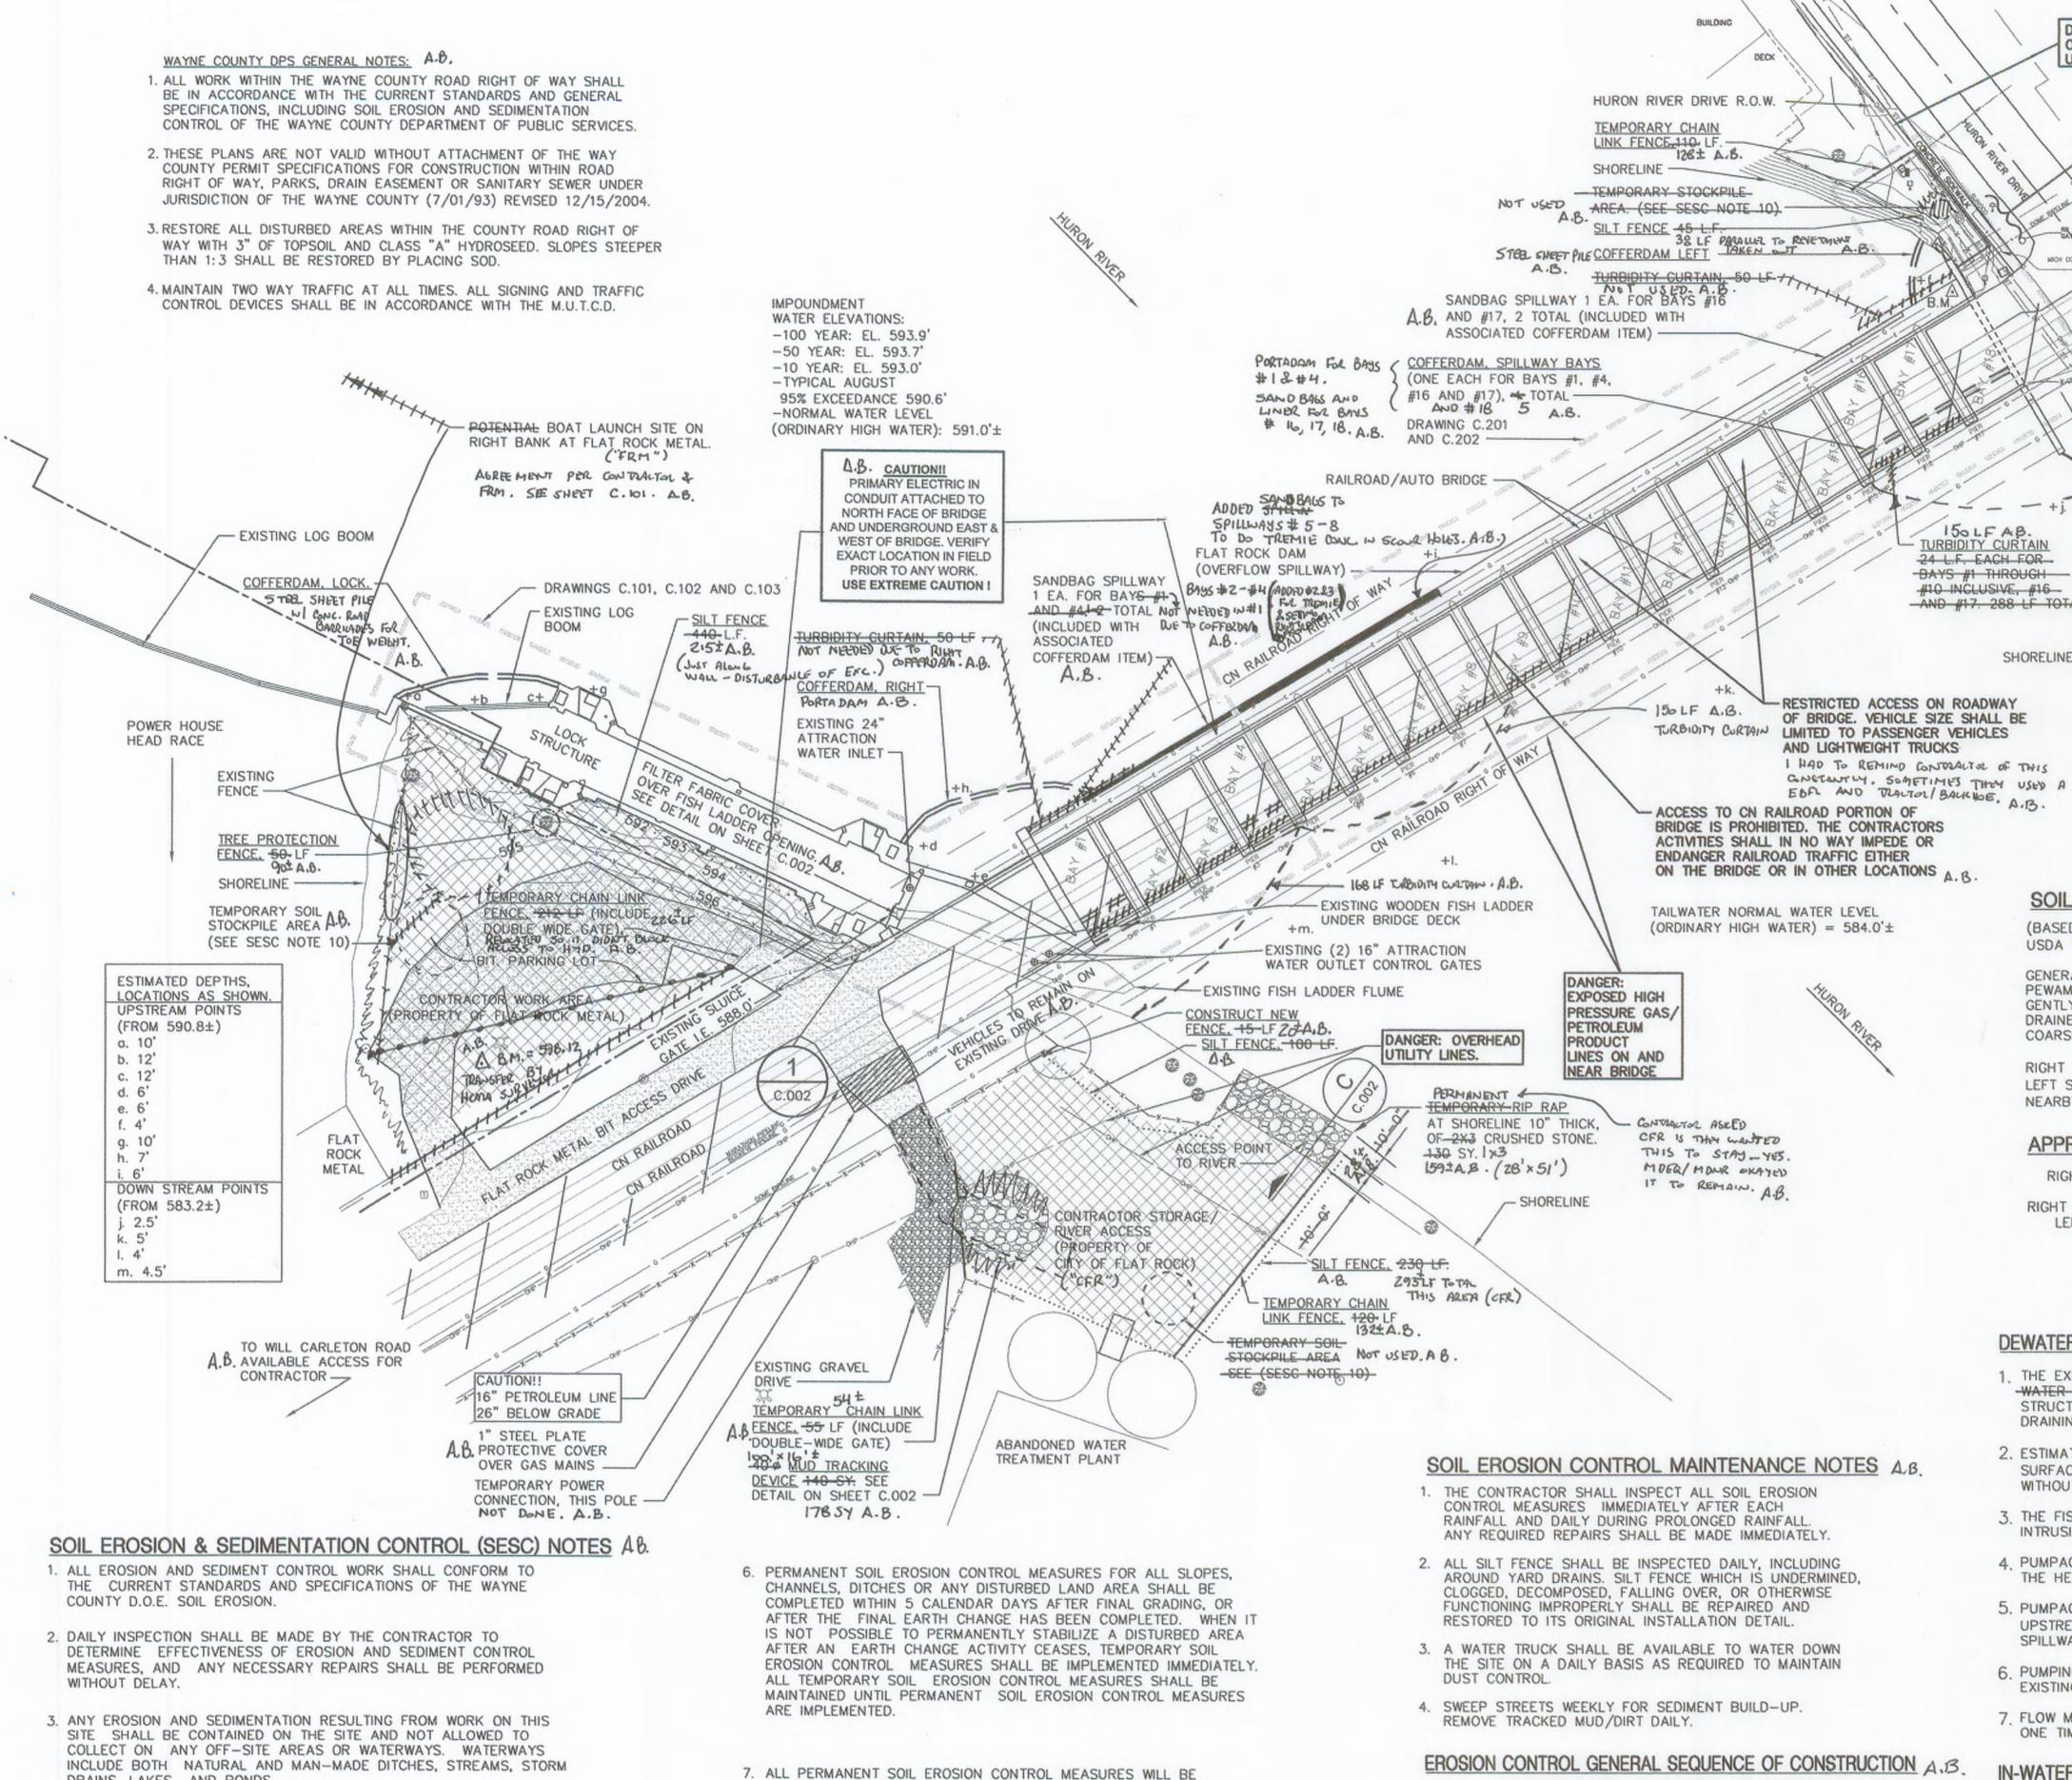- 1. INSTALL TEMPORARY FENCING AS SHOWN ON PLANS.
- 2. INSTALL TEMPORARY EROSION CONTROL MEASURES INCLUDING SILT FENCE INLET FILTERS, TREE PROTECTION FENCING AND MUD TRACKING PAD.
- 3. EXCAVATE AND REMOVE FENCING, CONCRETE STRUCTURES AND OTHER ITEMS TO BE DEMOLISHED.
- 4. COMPLETE CONCRETE REPAIRS AND BACKFILL WHEN APPROVED BY ENGINEER.
- INSTALL PERMANENT LANDSCAPING.
- REMOVE TEMPORARY SOIL EROSION CONTROL MEASURES AFTER PERMANENT VEGETATION HAS BEEN ESTABLISHED.
- 7. RESTORE ALL LANDSCAPE AREAS, PAVEMENT AND CURBING DISTURBED DURING THE PROJECT TO ORIGINAL CONDITIONS.



JRBIDITY CURTAIN

BAYS #1 THROUGH --

#10 INCLUSIVE, #16

AND #17. 288 LF TOTAL

SHORELINE ----

SOIL TYPE

GENERAL:

ROAD ROW

(BASED ON 1977 SURVEY REPORT BY

PEWAMO-SELFRIDGE-CORUNNA ASSOCIATION: NEARLY LEVEL TO

GENTLY SLOPING, VERY POORLY DRAINED TO SOMEWHAT POORLY

RIGHT UPSTREAM: 0.46AC (THIS AREA INCLUDES AN EXISTING BIT PARKING LOT

1 THE EXISTING 4'0 FISH LADDER SLUICE GATE AND 24" ATTRACTION MALLES TO

THAT MAY ONLY BE USED AS A STOCKPILE AREA)

H.R. FISHERMAN'S ASSOC. COULDN'T GET

WORK. A.B.

DRAINED SOILS THAT HAVE A MODERATELY FINE TEXTURED TO

-WATER LINE-ARE AVAILABLE TO AID IN DEWATERING THE LOCK

2. ESTIMATED DEWATERING ELEVATION FOR LOCK=587.0' LOCK WATER

3. THE FISH LADDER MUST BE PROTECTED AT ALL TIMES FROM THE

4. PUMPAGE FROM THE RIGHT COFFERDAM SHALL BE DISCHARGED AT

UPSTREAM OF DAM AT A LOCATION 10' MINIMUM FROM ANY ACTIVE

6. PUMPING DISCHARGE SHALL NOT BE ALLOWED TO ERODE OR SCOUR

7 FLOW MAY BE CUT OFF FROM A MAXIMUM OF 3 SPILLWAY BAYS AT

OF TEMP. COFFERDAMS. A.B.

IN-WATER GENERAL SEQUENCE OF CONSTRUCTION A.B.

(FOR EACH SEPARATE CONSTRUCTION AREA, THE TYPICAL SEQUENCE

1 INSTALL ALL UPSTREAM AND DOWNSTREAM TURBIDITY CURTAINS AS

STRUCTURES, REVETMENTS, RIP RAP, AND/OR TREMIE CONCRETE.

5. PRIOR TO REMOVAL OF TURBIDITY CURTAINS, ALLOW ALL SUSPENDED

MATERIAL TO SETTLE. REMOVE SILTS THAT HAVE COLLECTED ON THE

2. IF APPLICABLE TO LOCATION, INSTALL COFFERDAM AND DEWATER.

4. AS APPLICABLE, TURN OFF DEWATERING AND EQUALIZE WATER

3. DEMOLISH OLD CONCRETE AND CONSTRUCT NEW CONCRETE

BOTTOM OR IN THE FABRIC AND DISPOSE OF OFF SITE.

ONE TIME. STANTER OKAY WITH MORE THAN 3 - CONTRACTORS RISK

5. PUMPAGE FROM SPILLWAY BAYS SHALL DISCHARGE IN TO RIVER

INTRUSION OF SILTS, DEBRIS OR OTHER DAMAGE.

STRUCTURE; HOWEVER, PUMPING MAY BE REQUIRED IN ADDITION TO

SURFACE ELEVATION SHALL NOT BE DRAWN DOWN BELOW 586.0' A.B.

WITHOUT PERMISSION OF ENGINEER. (DESIGN PEX CONTRACTORS) A.B.

USDA SOIL CONSERVATION SERVICE)

COARSE TEXTURED SUBSOIL.

RIGHT SIDE: (BbB) BLOUT LOAM

RIGHT DOWNSTREAM: 0.34AC

DEWATERING NOTES A.B.

THE HEAD OF THE LOCK.

EXISTING EARTH.

LEFT UPSTREAM: 0.06AC

DRAINING THROUGH GRAVITY OUTLETS.

OF CONSTRUCTION SHALL BE AS FOLLOWS)

CURE AND FINISH CONCRETE AS REQUIRED.

SHOWN ON DRAWINGS. A.G.

LEVELS. REMOVE COFFERDAM.

TOTAL: 0.86AC

LEFT SIDE: (MhB) METEA LOAMY SAND

APPROXIMATE DISTURBED ACREAGE

NEARBY: (ShB) SHOALS SILT LOAM

24 L.F. EACH FOR



Stantec Consulting Michigan Ltd. 3959 Research Park Drive Ann Arbor MI U.S.A. 48108-2216 Tel. 734.761.1010 Fox. 734.761.1200 www.stantec.com

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Legend	
= =	== = COFFERDAM
	TURBIDITY CURTAIN
	SILT FENCE
	TREE PROTECTION FENCE
	TEMPORARY CHAINLINK FENCE
	RIGHT OF WAY
∠°\ E	OCAL DATUM BENCHMARK: AST SIDE OF SPILLWAY AT LEFT PSTREAM RETAINING WALL = 590.5' BASED ON ORIGINAL STONE & WEBSTER DRA
8	GATE VALVE
0	STORM SEWER MANHOLE
Ø	POWER POLE
(S)	SANITARY SEWER MANHOLE
0	WATER MANHOLE
200	FIRE HYDRANT
<u></u>	BENCH MARK
G	GAS LINE
ST	STORM SEWER

OHP OVERHEAD POWER

	-			
AS-BUILT (A.B. ") DRAWING N	OT15-3	JRR		01.10
Revision		Ву	Appd.	MM.DD.YY
BID SET				05.08
(WCDPS) RESUBMITTAL				03.08
OWNER REVIEW				03.08
QA/QC (95%)		-		02.08
ROAD COMMISSION SUBMITTAL (WCDPS)	*************	Name and Address of the Owner, where	en a companyon	01.08
REVISIONS PER MDEQ				12.13.07
PERMITS (90% SET)				10.31.07
60% REVIEW				07.10.07
Issued		Ву	Appd.	MM.DD.YY
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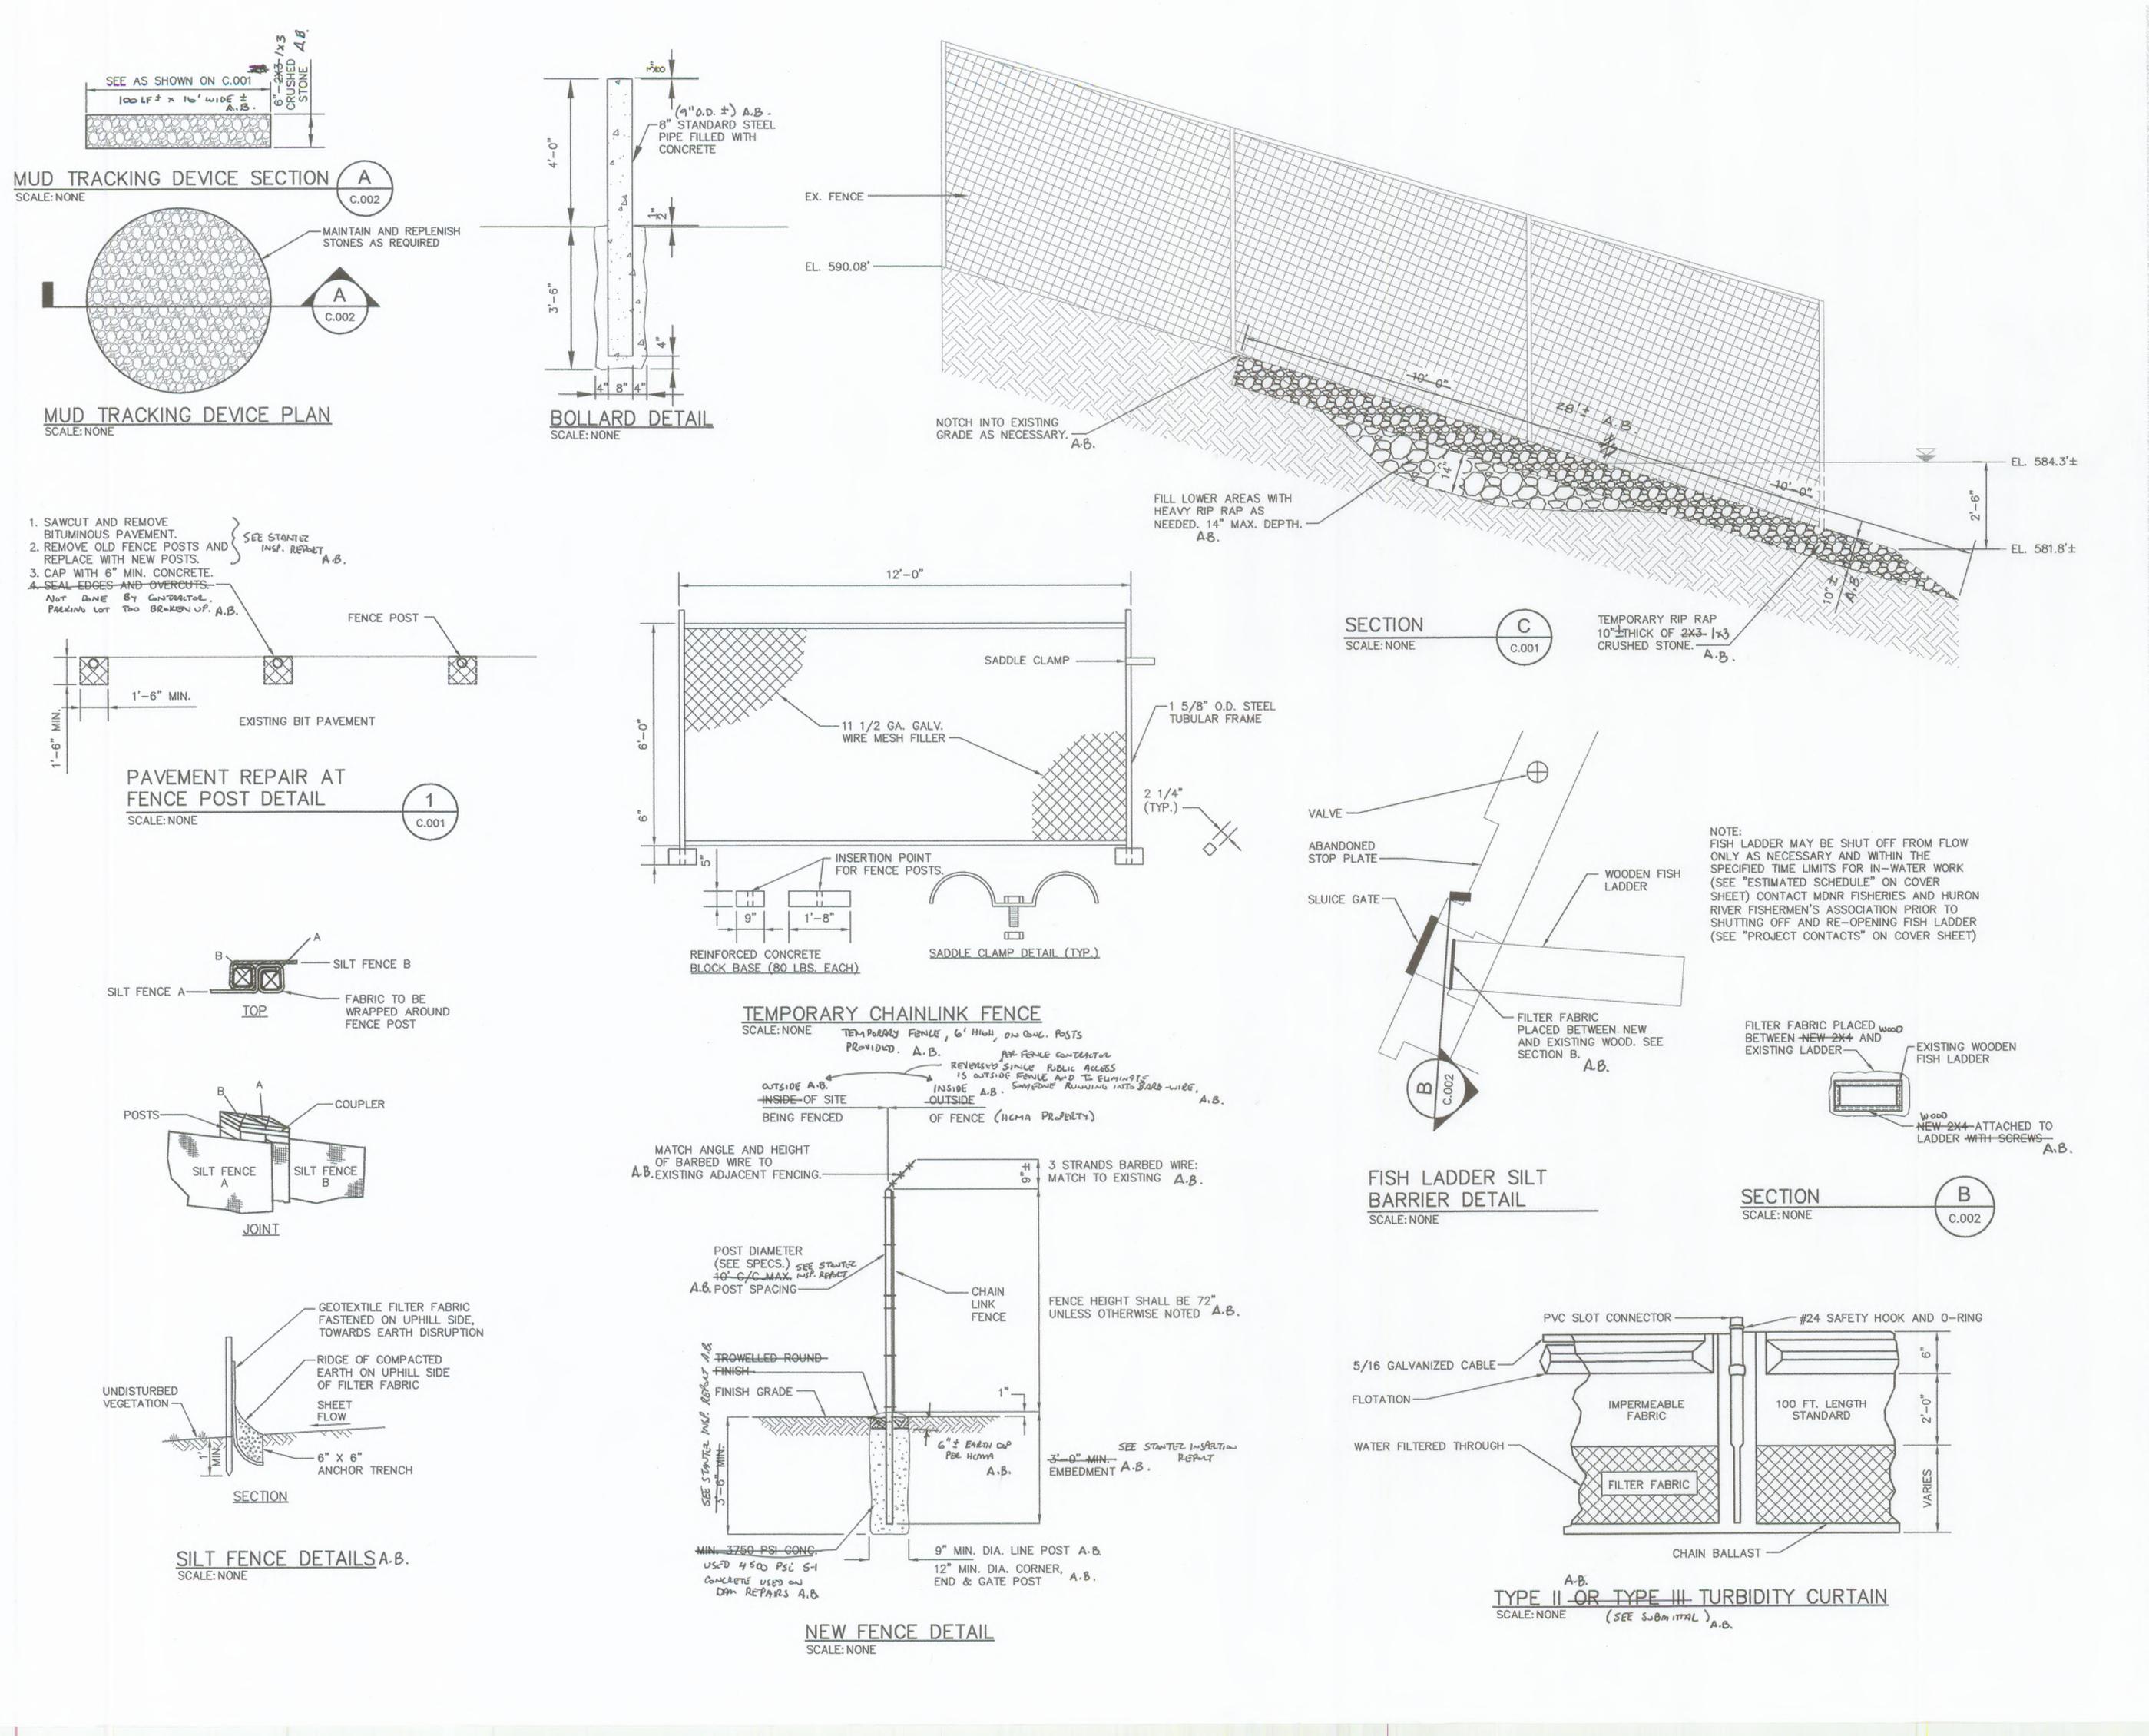
HURON-CLINTON METROPOLITAN AUTHORITY FLATROCK DAM 2008 REPAIRS

FLATROCK, MICHIGAN

OVERALL SITE PLAN

Project No.	Scale	
2075092501	1" = 40'	
Drawing No.	Sheet	Revisior

C.001





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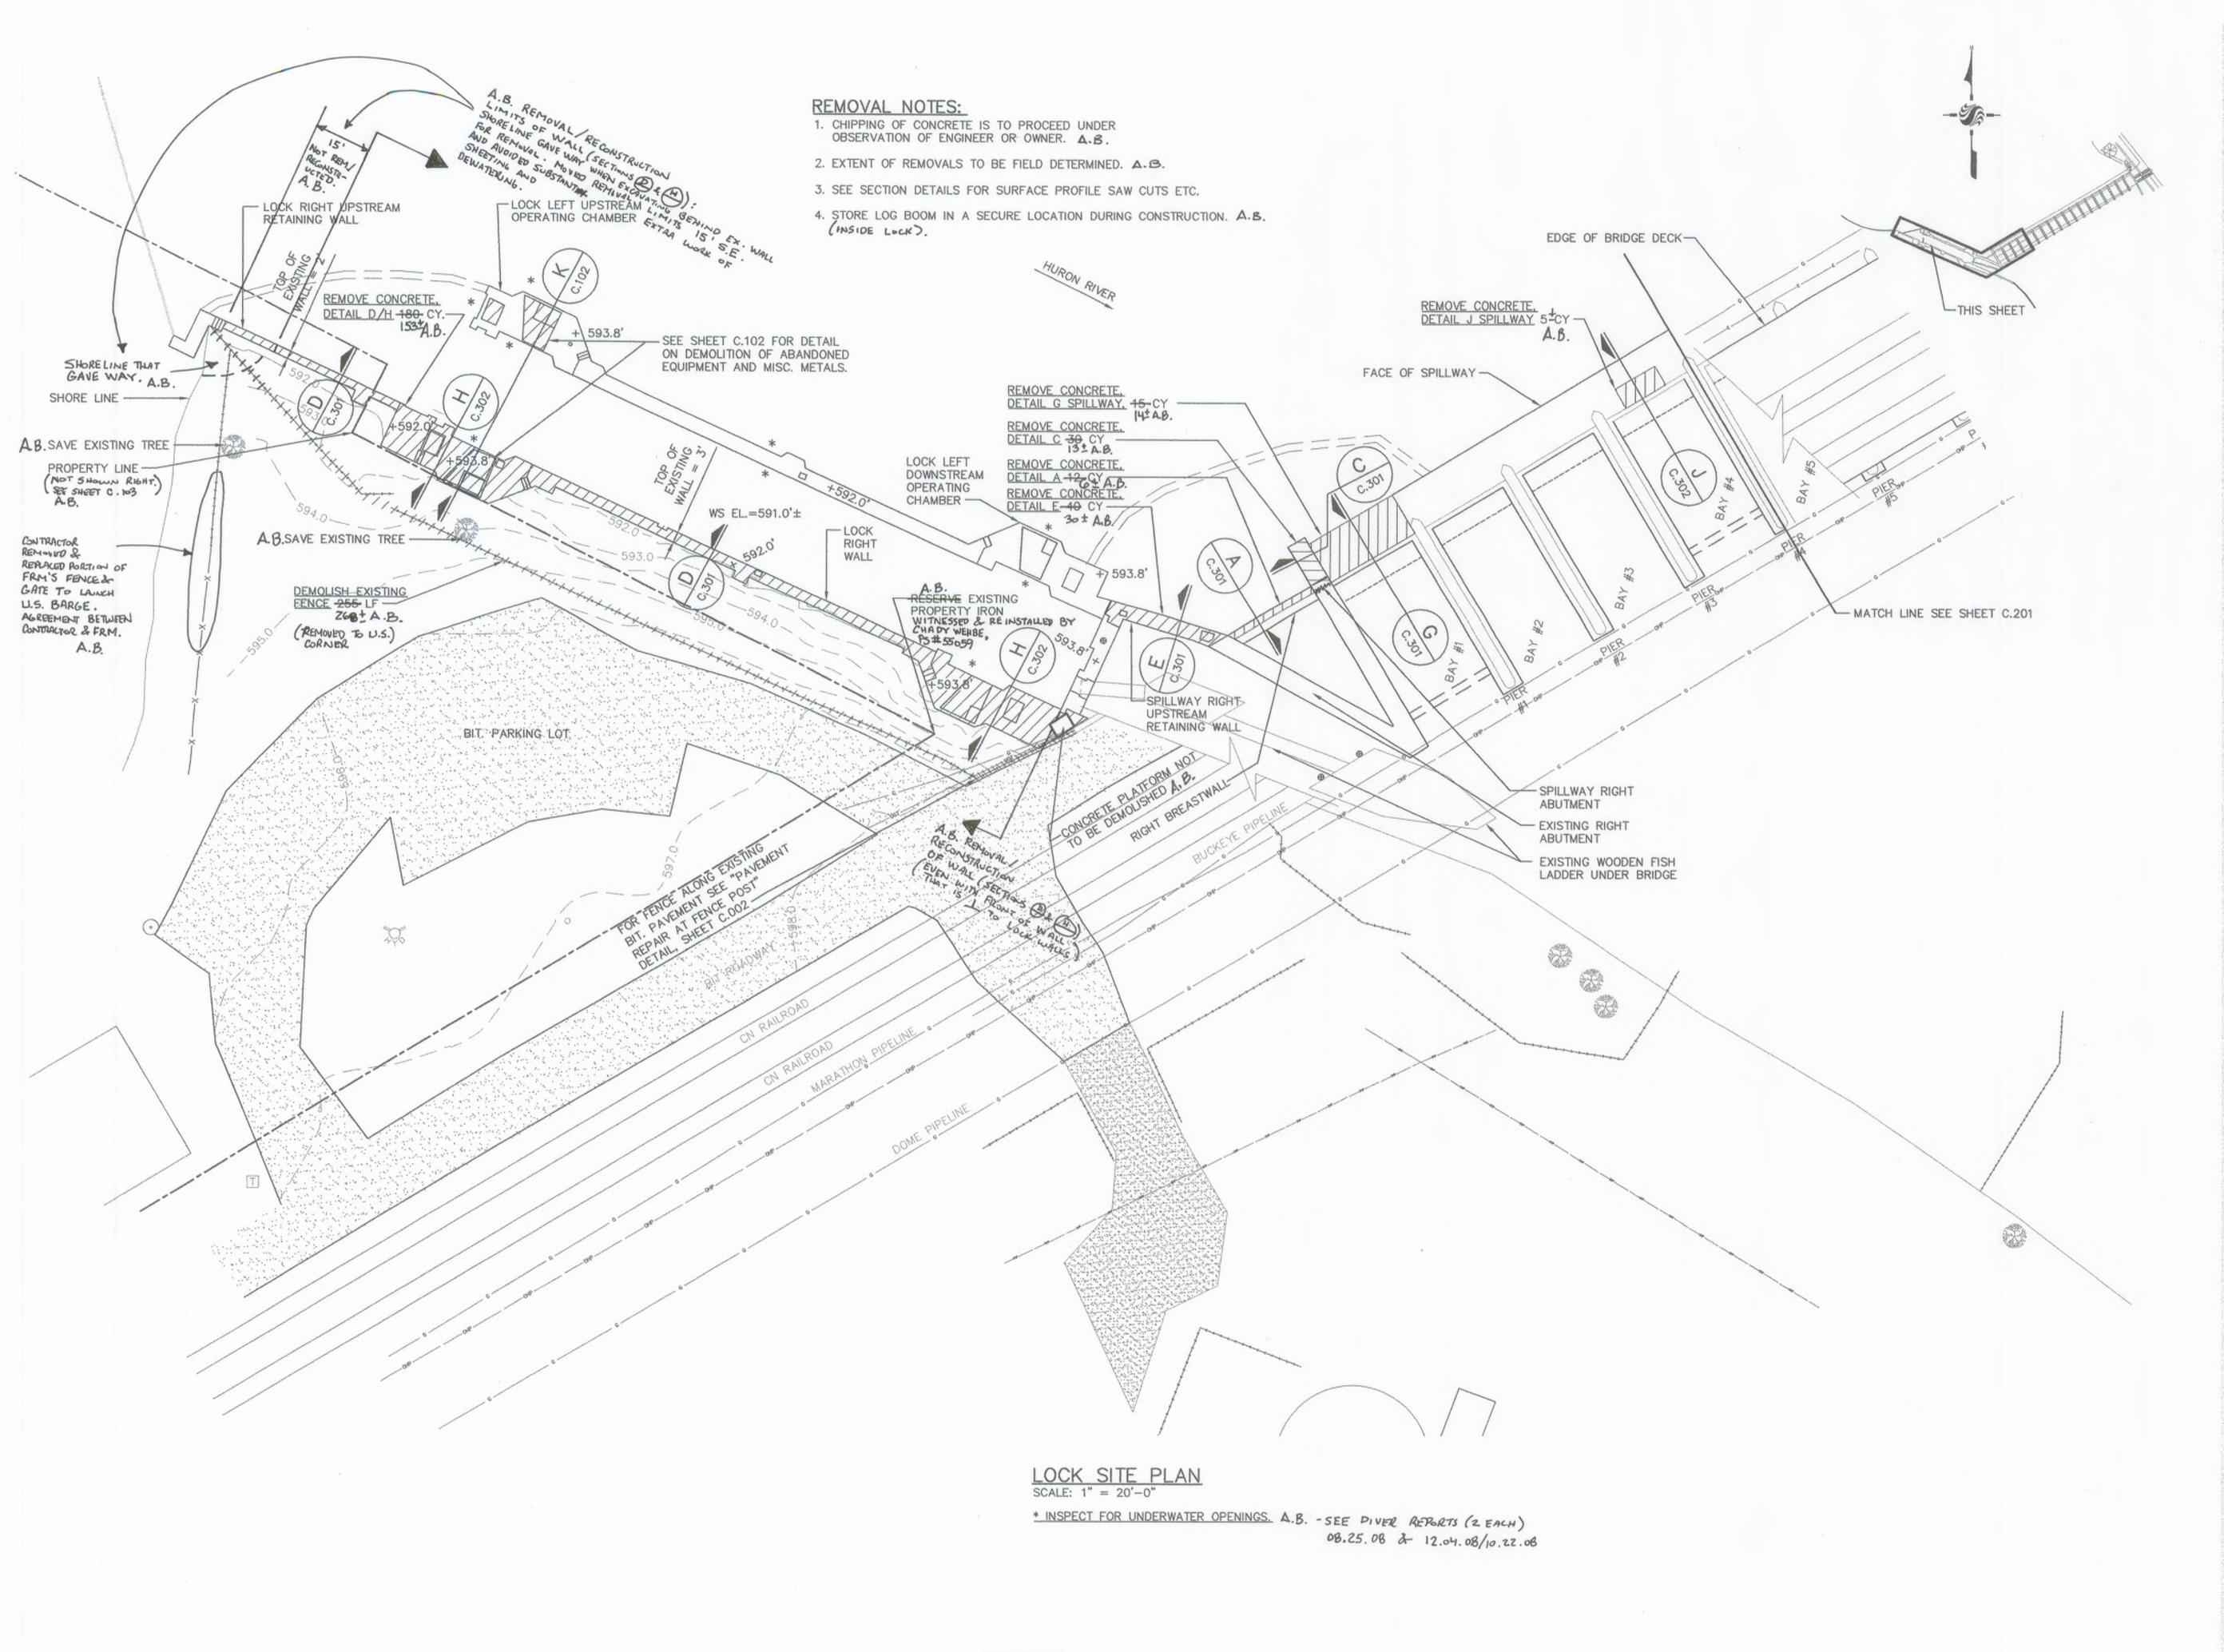
HURON-CLINTON METROPOLITAN AUTHORITY FLATROCK DAM 2008 REPAIRS

FLATROCK, MICHIGAN

Title

SOIL EROSION CONTROL AND MISC. DETAILS

Project No. 2075092501	Scale 1" = 40'	
Drawing No.	Sheet	Revision
C 002	of.	



SHOWS EQUIPMENT AND CONCRETE TO BE REMOVED.



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Legend

⊗ GATE VALVE

ONIE VALV

STORM SEWER MANHOLE

Ø POWER POLE

SANITARY SEWER MANHOLE

WATER MANHOLE

FIRE HYDRANT

BENCH MARK

G GAS LINE

ST STORM SEWER

OHP OVERHEAD POWER

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HURON-CLINTON METROPOLITAN AUTHORITY FLATROCK DAM 2008 REPAIRS

FLATROCK, MICHIGAN

RIGHT SIDE, LOCK DEMOLITION PLAN


 Project No.
 Scale

 2075092501
 AS-NOTED

 Drawing No.
 Sheet
 Revision

C.101

of

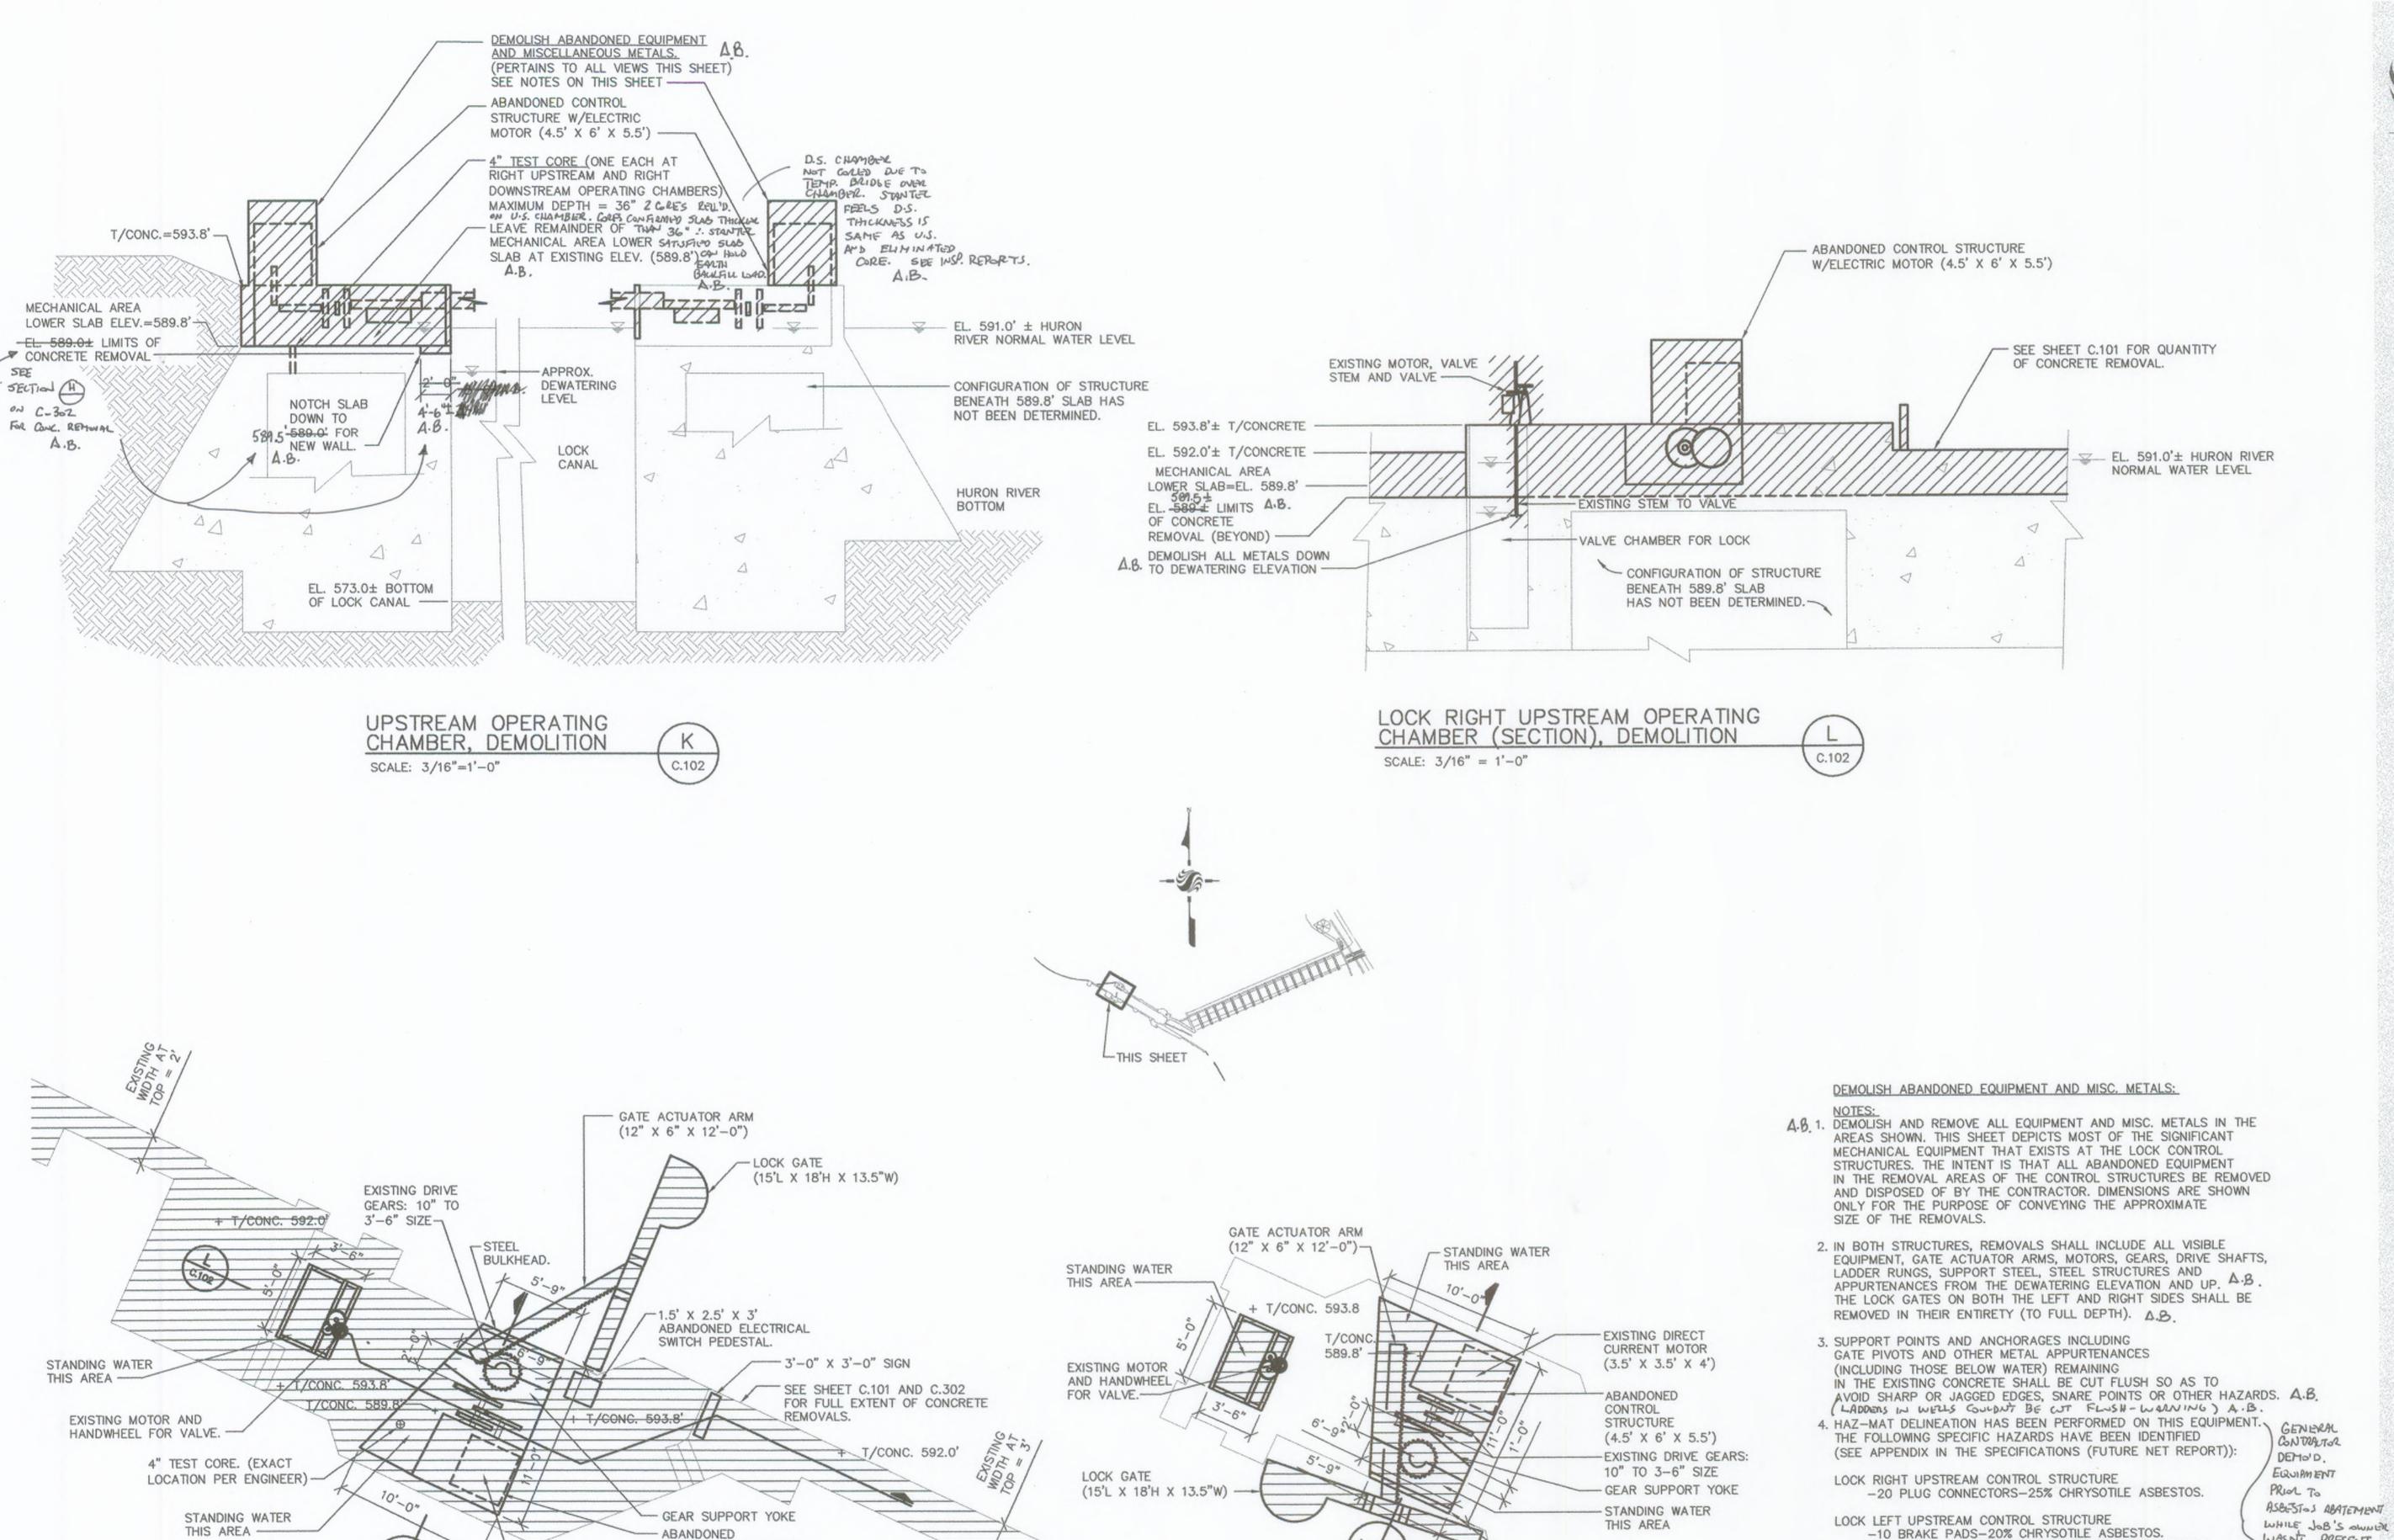

LOCK LEFT UPSTREAM OPERATING CHAMBER DEMOLITION

SCALE: 3/16" = 1'-0"

CONTROL STRUCTURE

(4.5' X 6' X 5.5')

EXISTING DIRECT

CURRENT MOTOR

(3.5' X 3.5' X 4')

OPERATING CHAMBER, DEMOLITION

LOCK RIGHT UPSTREAM

SCALE: 3/16" = 1'-0"



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File Name:	SMJ	DMD	PJM	
	Dwn.	Chkd.	Dsgn.	MM.DD.YY
Permit-Seal				

Client/Project

WASN'T PRESENT.

B.C. BROUGHT IN

FOR CLEAN-UP.

- NEVER RECEIVED

FROM G.C. DESATE

MANY ATTEMPTS.

ABATIMENT CONTRACTOR

AFTER BEING CAUGHT

(AS SPECID.).

-10 CABLE CONNECTORS-25% CHRYSOTILE ASBESTOS.

ALL PAINTED SURFACES SHOULD BE PRESUMED TO CONTAIN LEAD.

ALL PLUG CONNECTORS, CABLE CONNECTORS AND BRAKE PADS

CONCRETE AND EQUIPMENT REMOVAL A.B.

-1000 SF.-22% BY WT. LEAD BASED PAINT.

SHOULD BE PRESUMED TO CONTAIN ASBESTOS.


-STEEL BULKHEAD.

HURON-CLINTON METROPOLITAN AUTHORITY FLATROCK DAM 2008 REPAIRS

FLATROCK, MICHIGAN

ABATEMENT REPORTS Title RIGHT SIDE, LOCK **DEMOLITION DETAILS**

Project No.	Scale	
2075092501	AS-NOTED	
Drawing No.	Sheet	Revision
C.102	of	

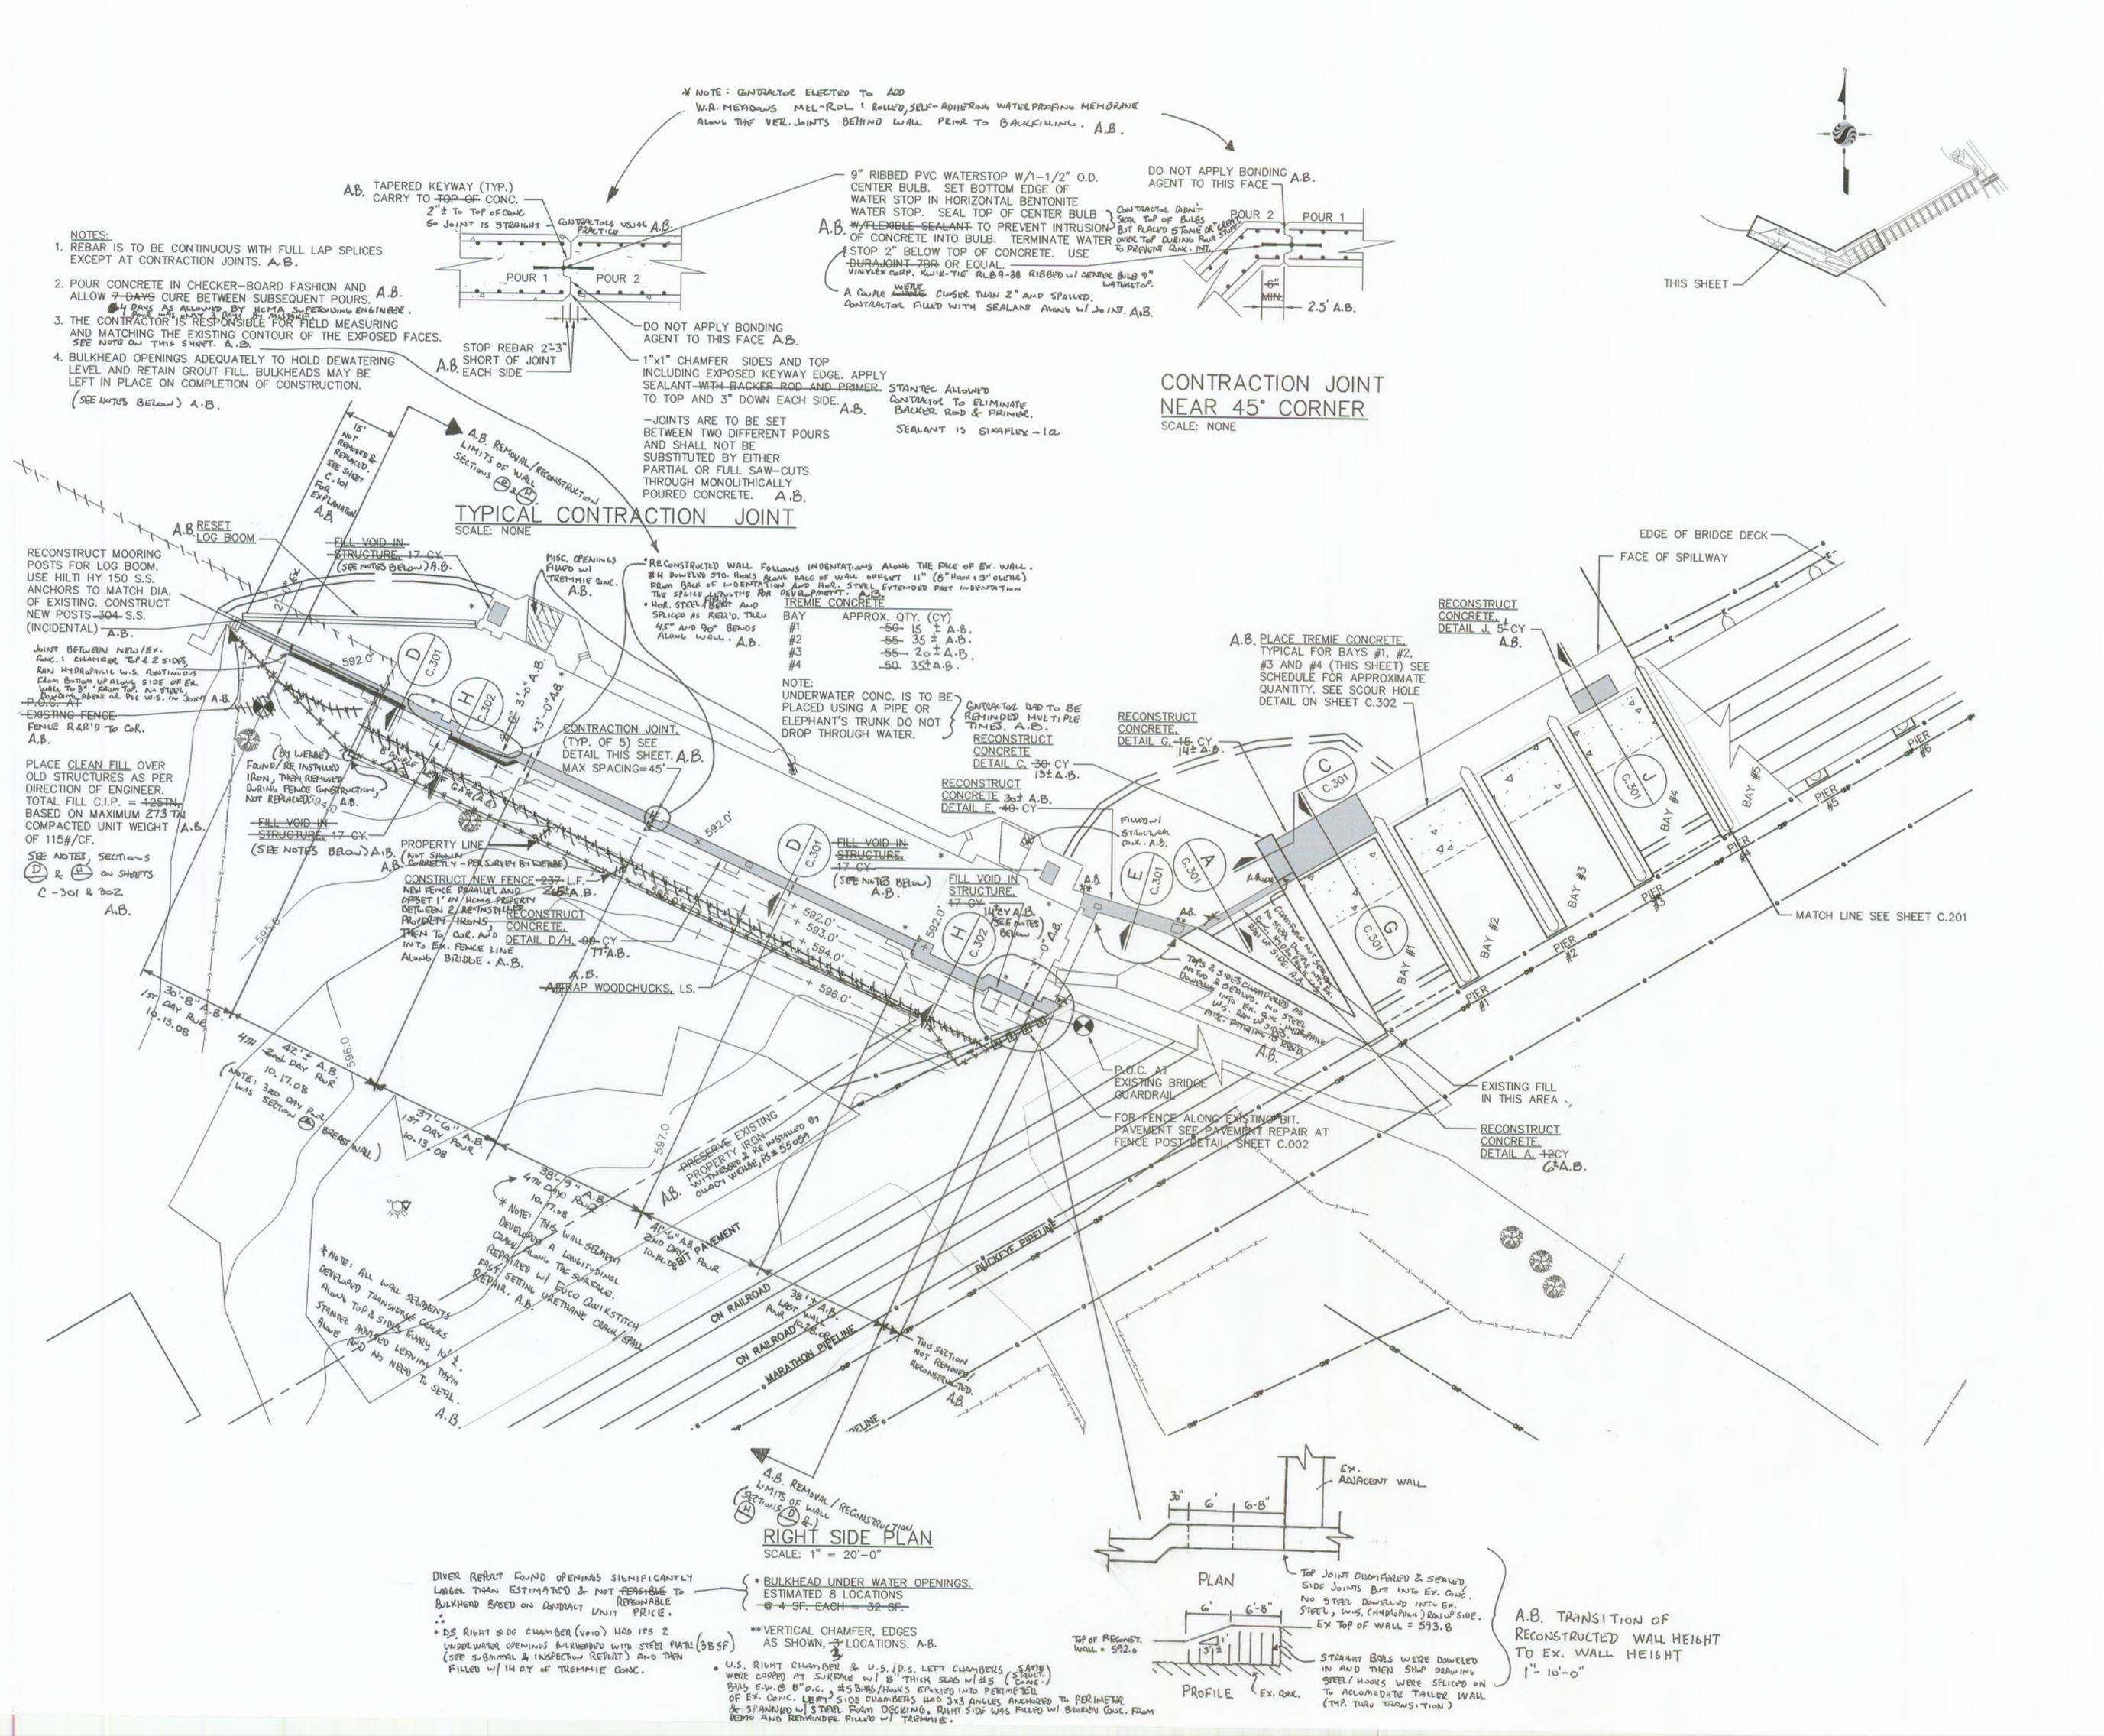



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Consultants

Legend

- ⊗ GATE VALVE
- STORM SEWER MANHOLE
- Y POWER POLE
- SANITARY SEWER MANHOLE
- WATER MANHOLE
- FIRE HYDRANT
- BENCH MARK
- G GAS LINE
- ST STORM SEWER
- OHP OVERHEAD POWER

UNDERLINED NOTES ARE PAY ITEMS.

AS-BUILT ("A.B.") DRAWING NO	ES JRR		01.10
Revision	Ву	Appd.	MM.DD.YY
BID SET			05.08
OWNER REVIEW			03.08
QA/QC (95%)			02.08
ROAD COMMISION SUBMITTAL (WCDPS)			01.08
PERMITS (90% SET)			10.31.07
60% REVIEW			07.07.10
Issued	Ву	Appd.	MM.DD.YY

Dwn. Chkd. Dsgn. MM.DD.YY

Permit-Seal

Client/Project

HURON-CLINTON METROPOLITAN AUTHORITY FLATROCK DAM 2008 REPAIRS


FLATROCK, MICHIGAN

RIGHT SIDE RECONSTRUCTION PLAN

Project No. 2075092501	Scale AS-NOTED	
Drawing No.	Sheet	Revision
C 102		

C.103

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Consultants

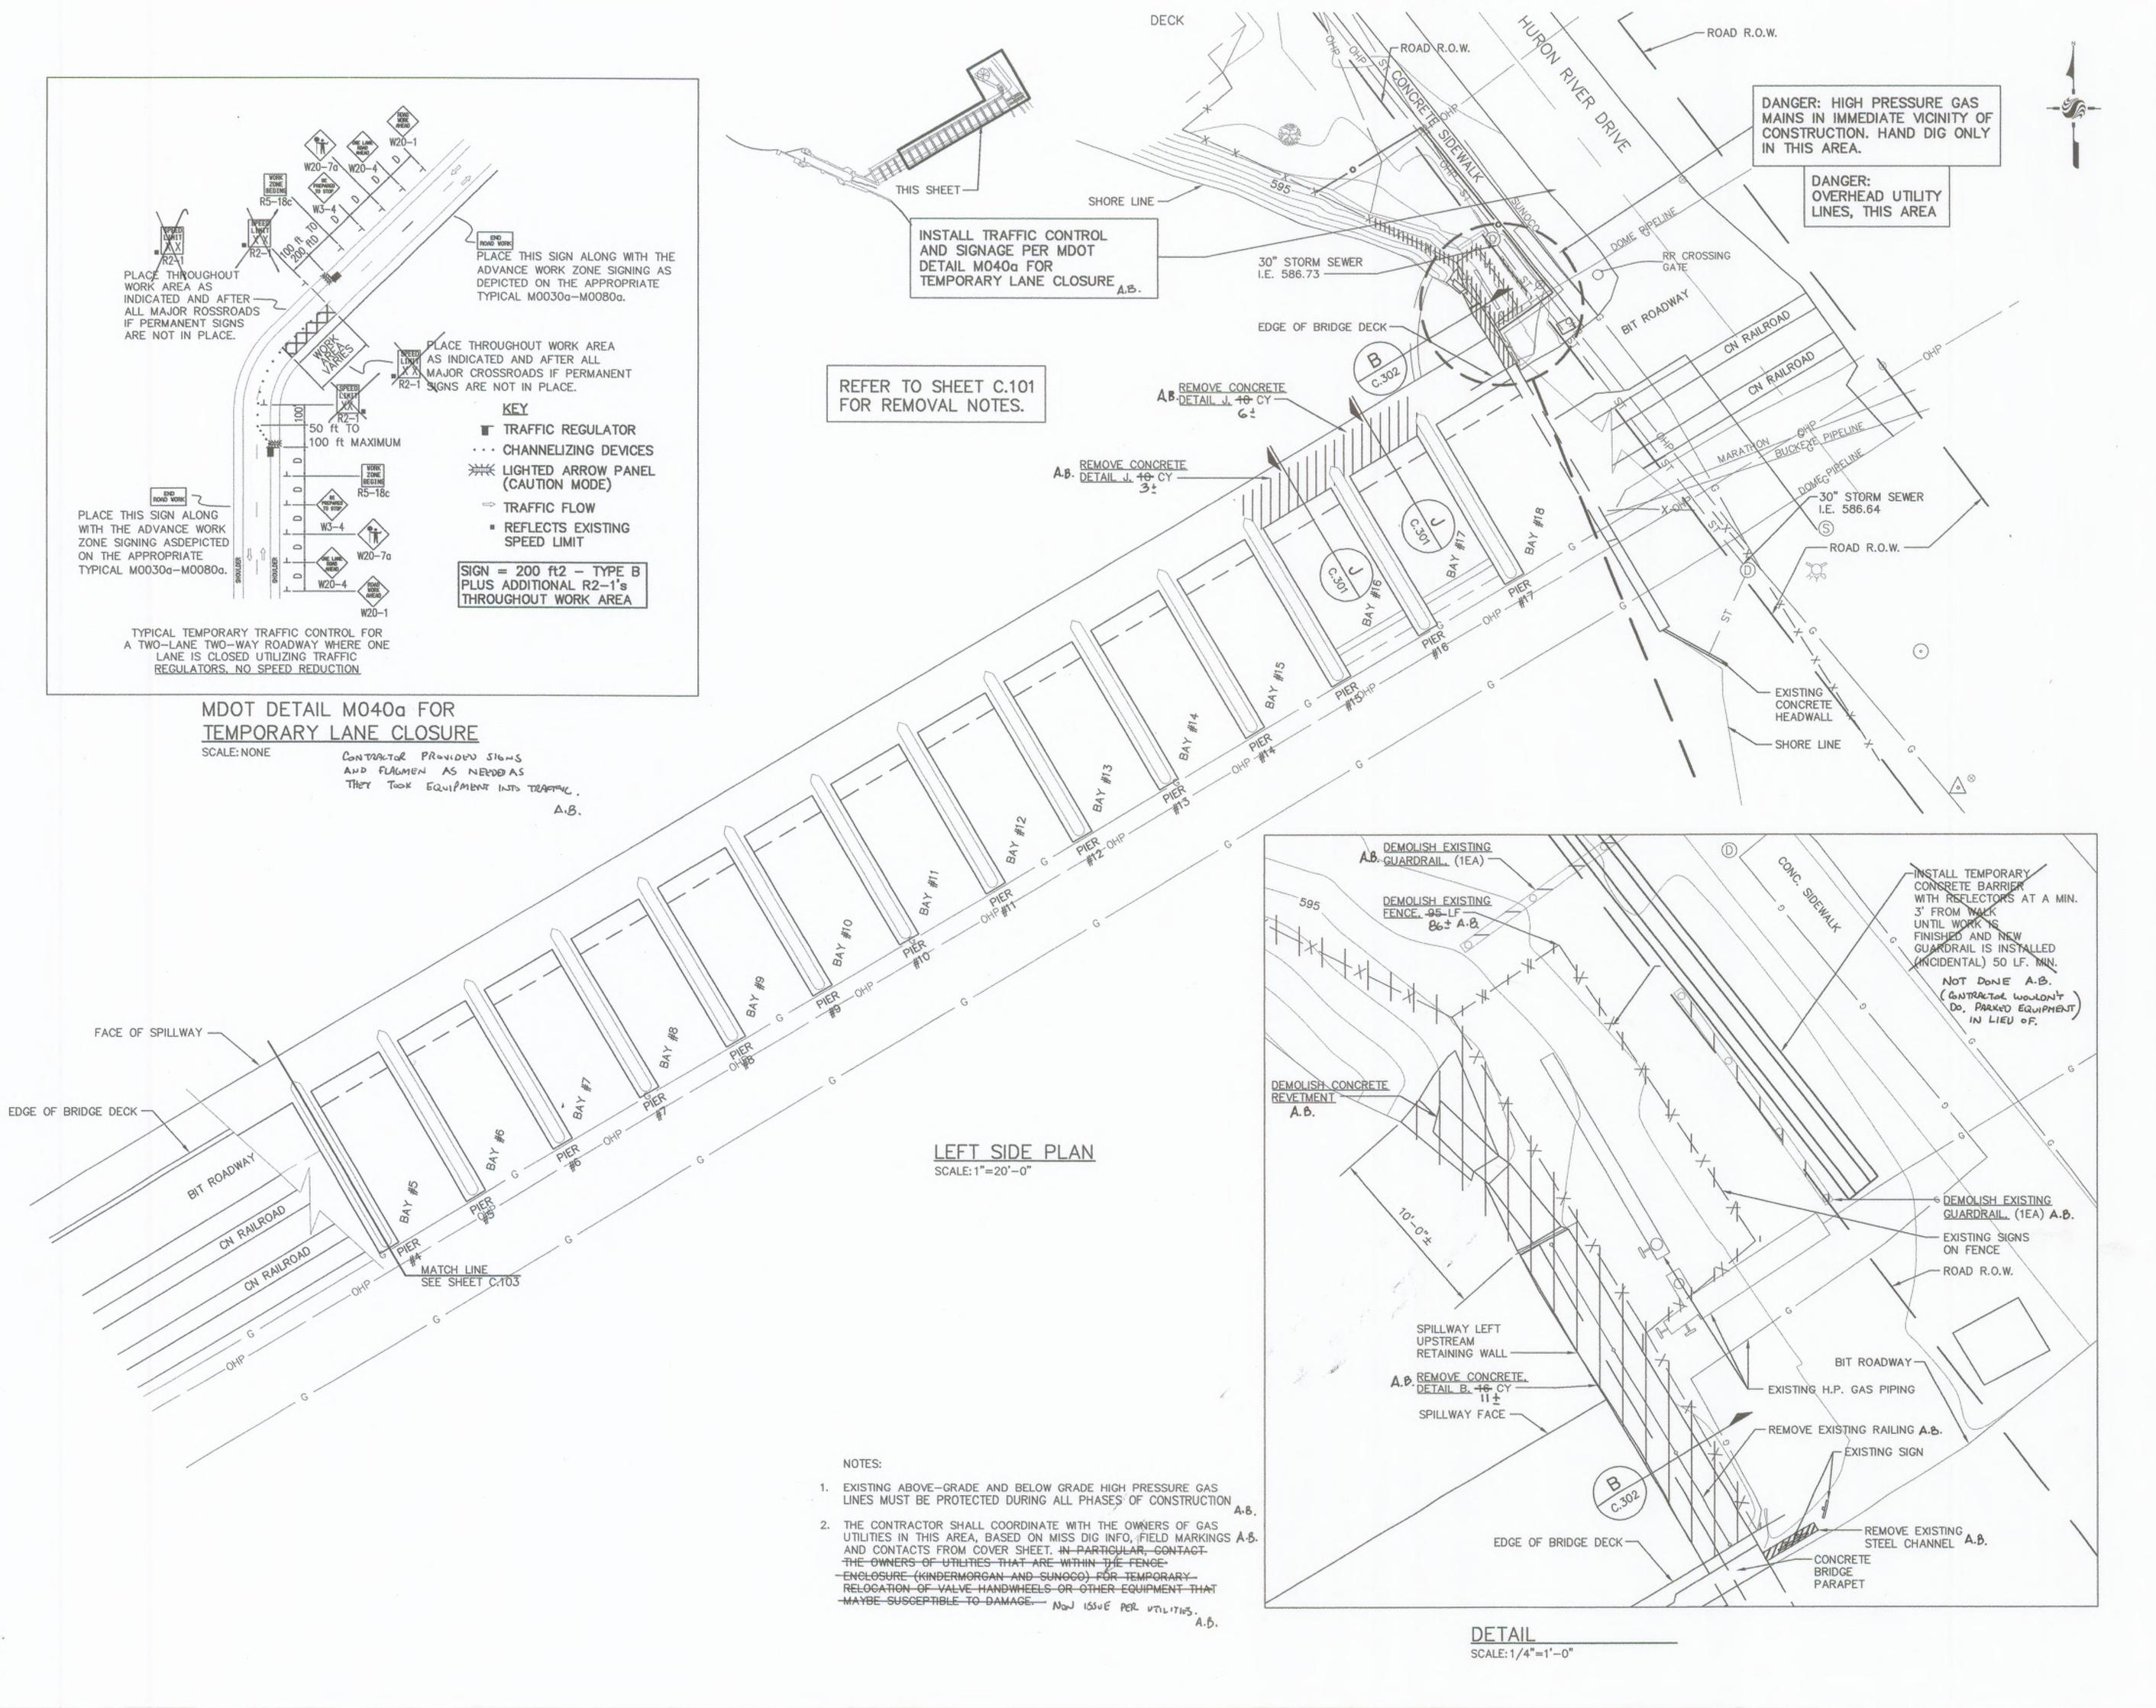Legend

- ⊗ GATE VALVE
- STORM SEWER MANHOLE
- Ø POWER POLE
- (S) SANITARY SEWER MANHOLE
- WATER MANHOLE
- FIRE HYDRANT
- BENCH MARK
- G GAS LINE
- ST STORM SEWER
- OHP OVERHEAD POWER

UNDERLINED NOTES ARE PAY ITEMS.

AS-BUILT ("A.B.") DRAWING NOTES	JRR	-	01.10
Revision	Ву	Appd.	MM.DD.YY
BID SET			05.08
OWNER REVIEW			03.08
QA/QC (95%)			02.08
ROAD COMMISION SUBMITTAL (WCDPS)		-	01.08
PERMITS (90% SET)			10.31.07
60% REVIEW			07.07.10
Issued	Ву	Appd.	MM.DD.YY
File Name: SMJ	DMD	PJM	
Dwn.	Chkd.	Dsgn.	MM.DD.Y

Client/Project

Permit-Seal

HURON-CLINTON METROPOLITAN AUTHORITY FLATROCK DAM 2008 REPAIRS

FLATROCK, MICHIGAN


itle

LEFT SIDE DEMOLITION PLAN

Project No.	Scale	
2075092501	AS NOTED	
Drawing No.	Sheet	Revision

C.201

of

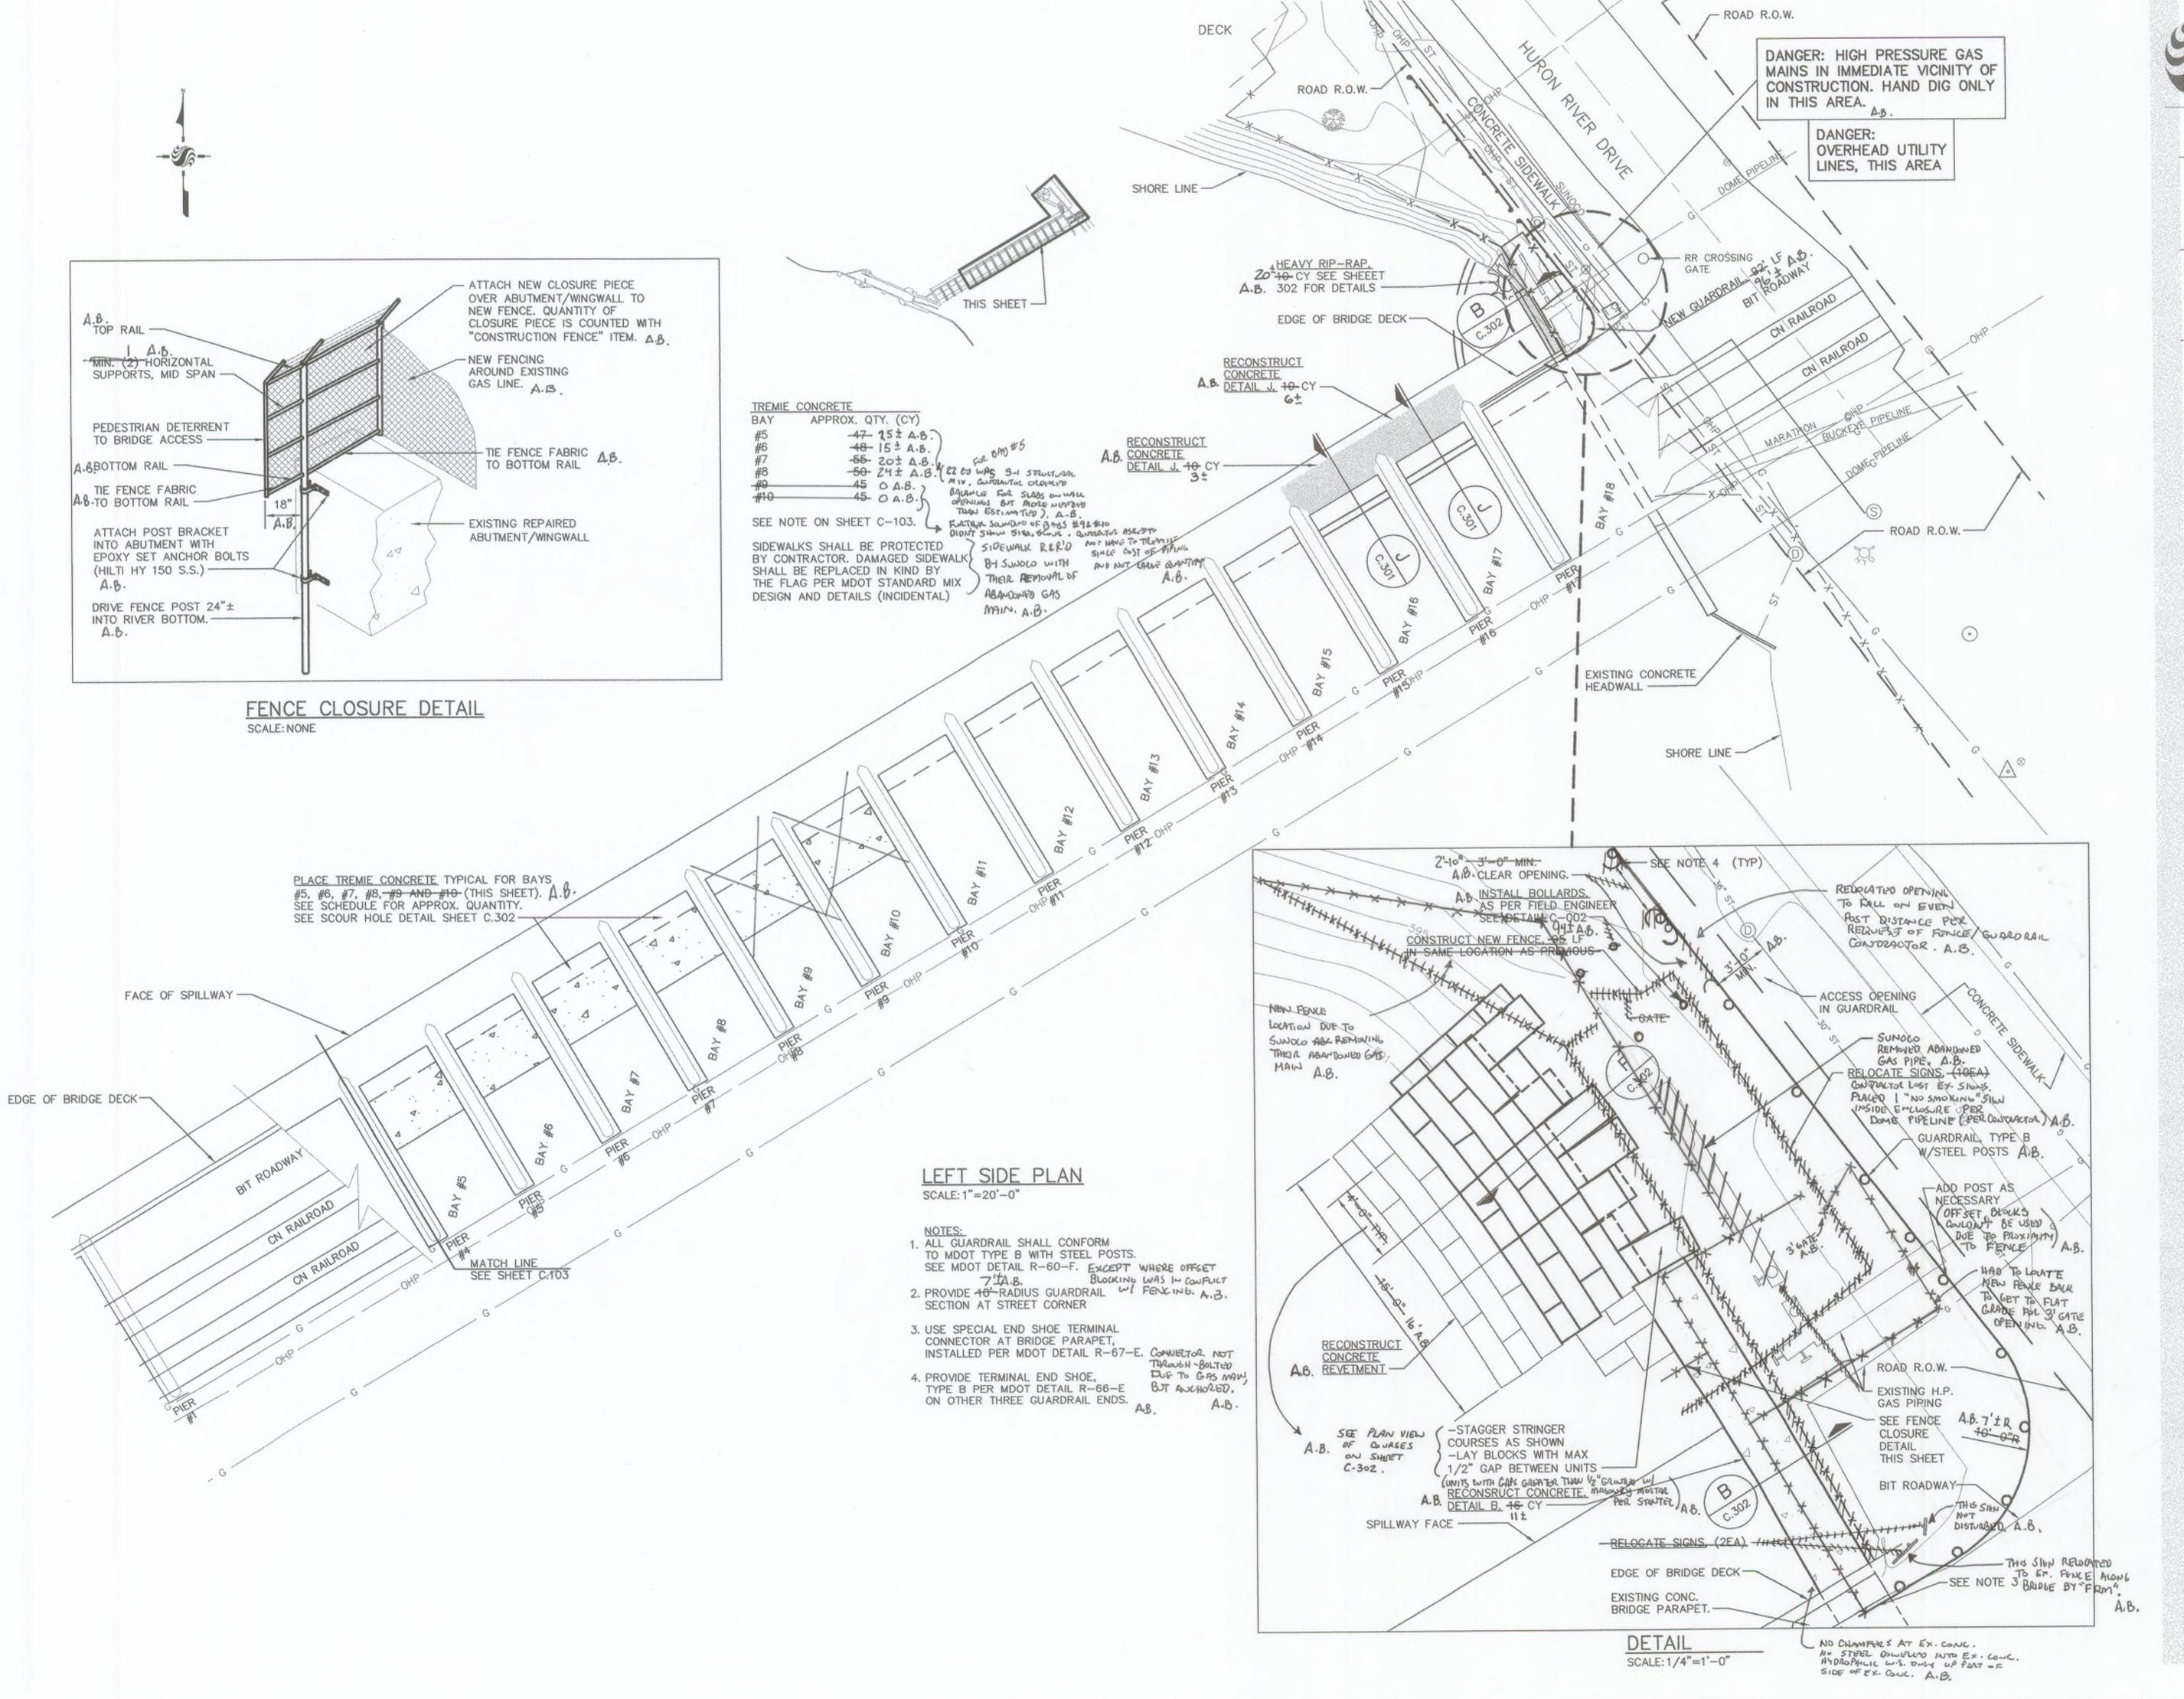



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Consultants

Legend

- ⊗ GATE VALVE
- STORM SEWER MANHOLE
- POWER POLE
- SANITARY SEWER MANHOLE
- WATER MANHOLE
- FIRE HYDRANT
- BENCH MARK
- GAS LINE
- ST STORM SEWER
- OHP OVERHEAD POWER

UNDERLINED NOTES ARE PAY ITEMS.

AS-BULT ("A.B.") DRAWING NOTES JRR Appd. MM.DD.YY BID SET 03.08 OWNER REVIEW 02.08 QA/QC (95%) 01.08 ROAD COMMISION SUBMITTAL (WCDPS) 10.31.07 PERMITS (90% SET) 60% REVIEW By Appd. MM.DD.YY Issued SMJ DMD PJM

Dwn. Chkd. Dsgn. MM.DD.YY

Client/Project


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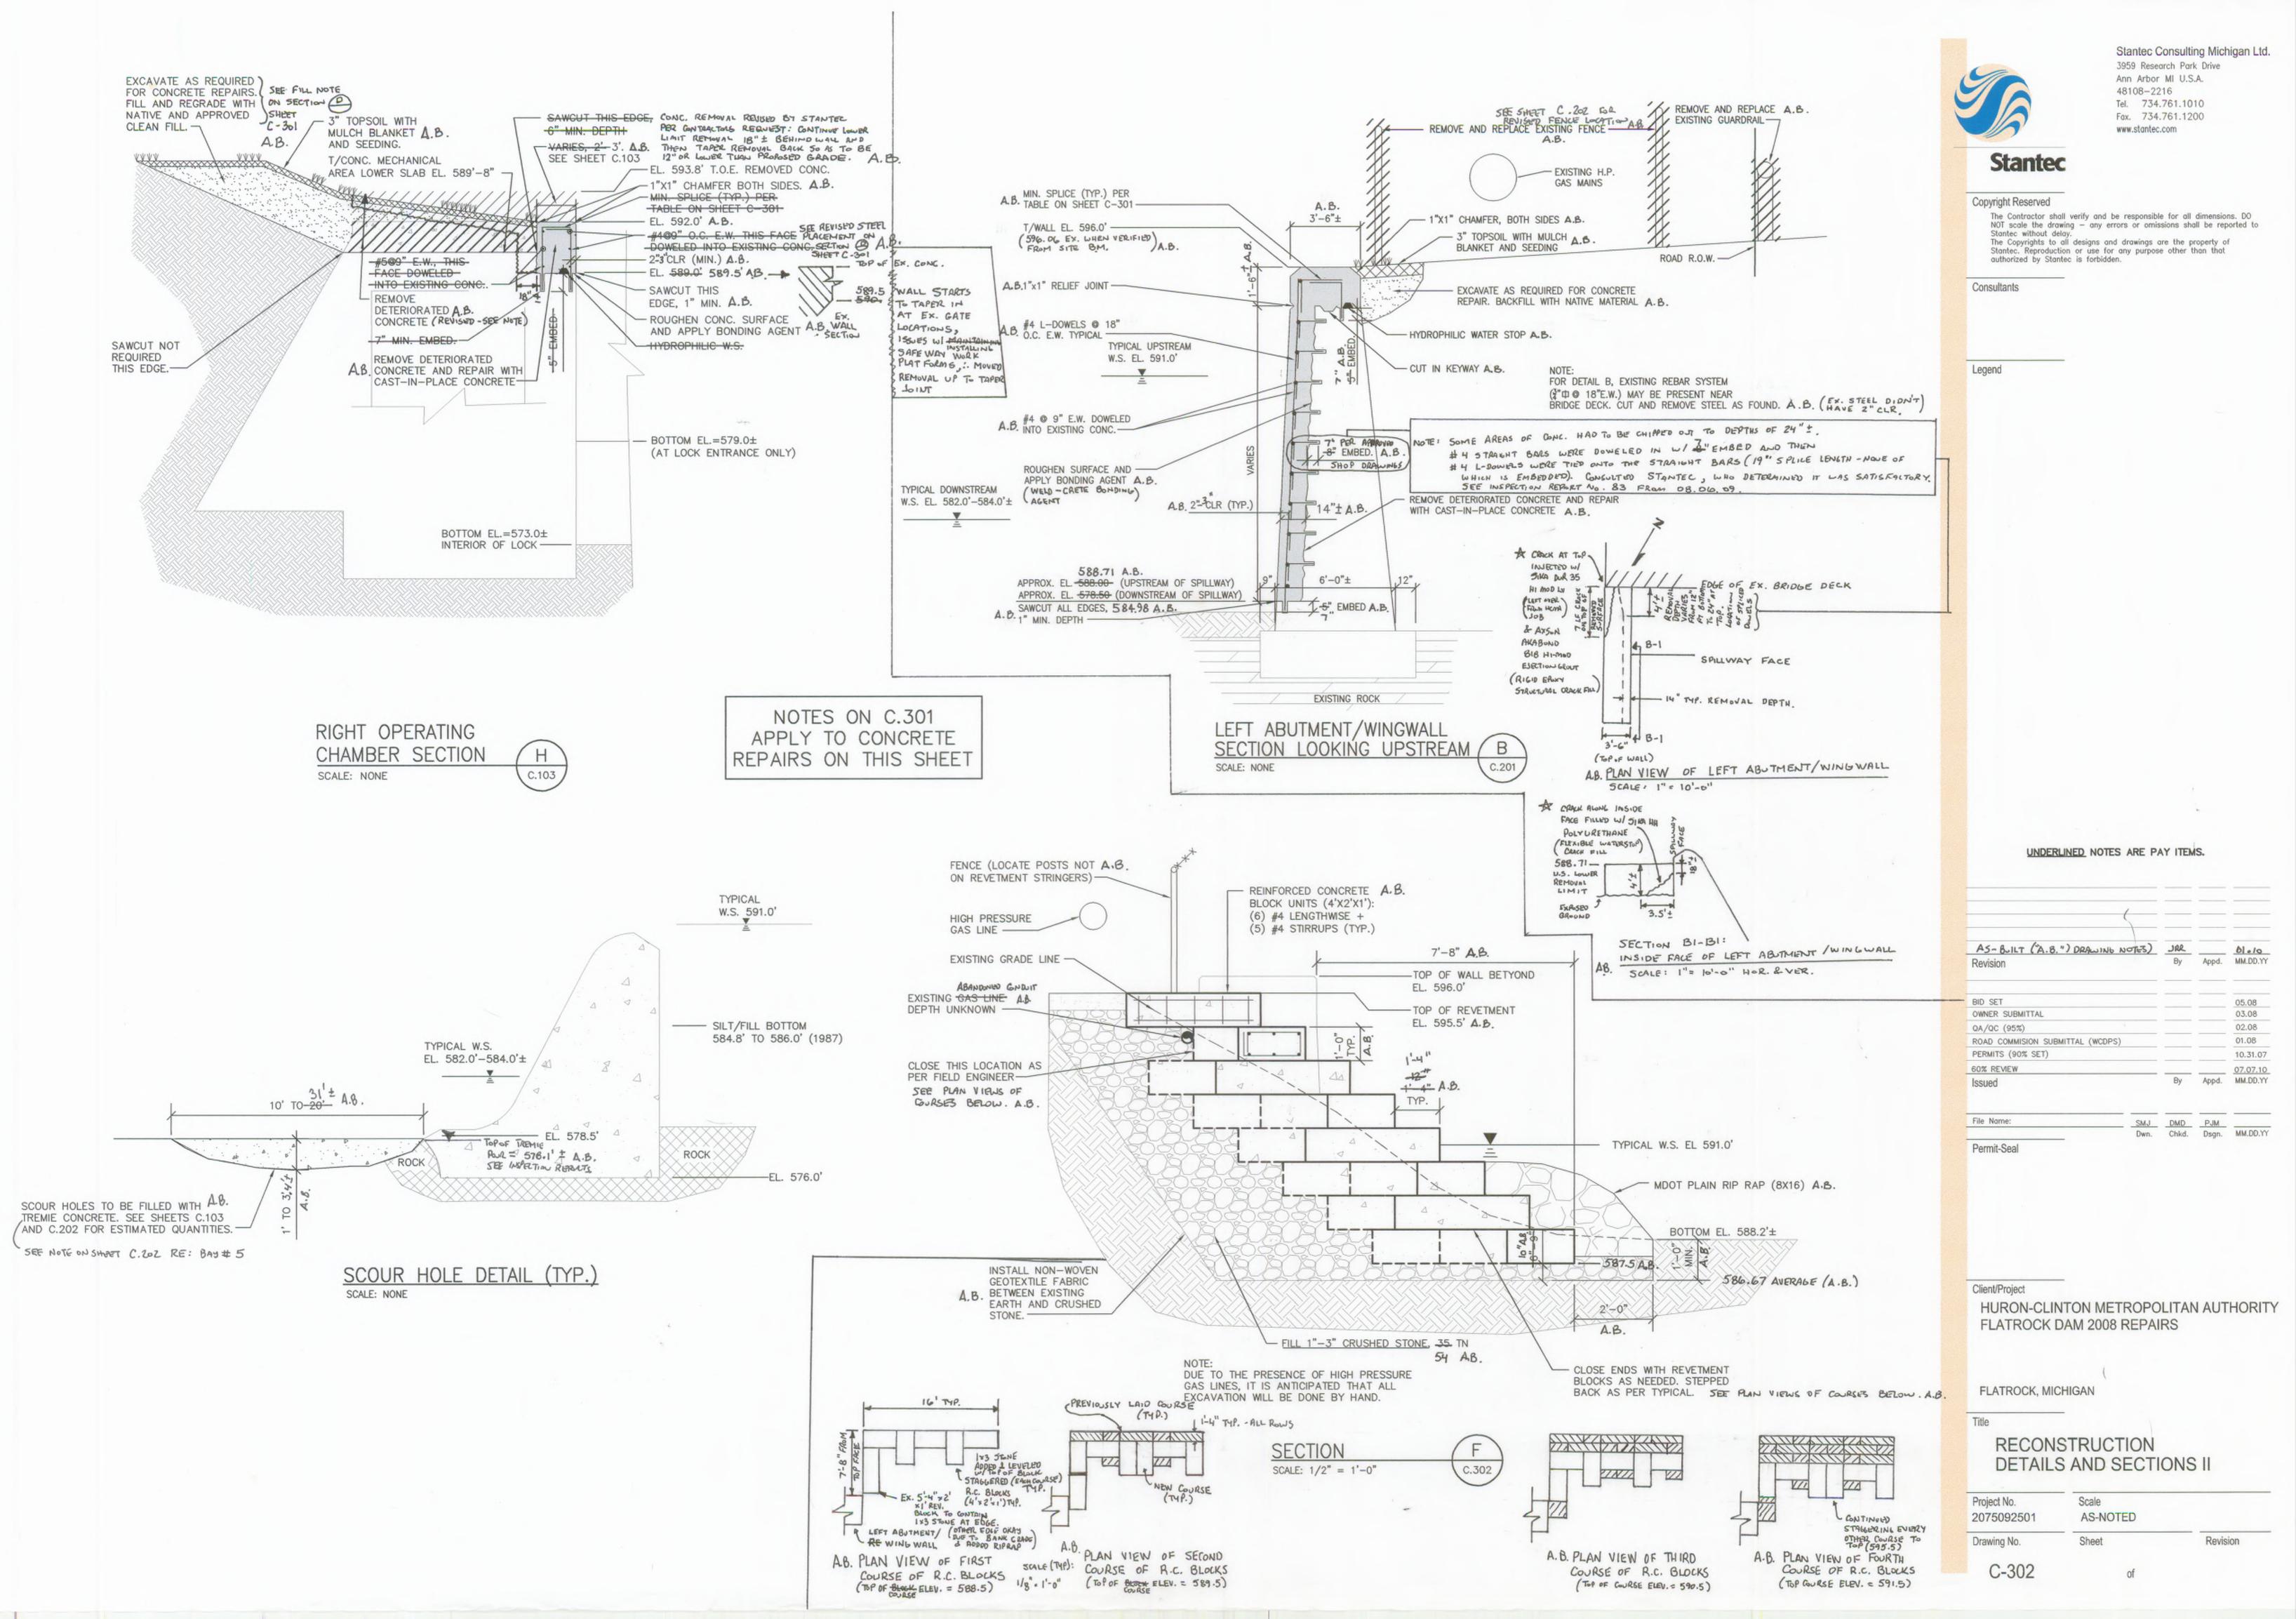
HURON-CLINTON METROPOLITAN AUTHORITY FLATROCK DAM 2008 REPAIRS


FLATROCK, MICHIGAN


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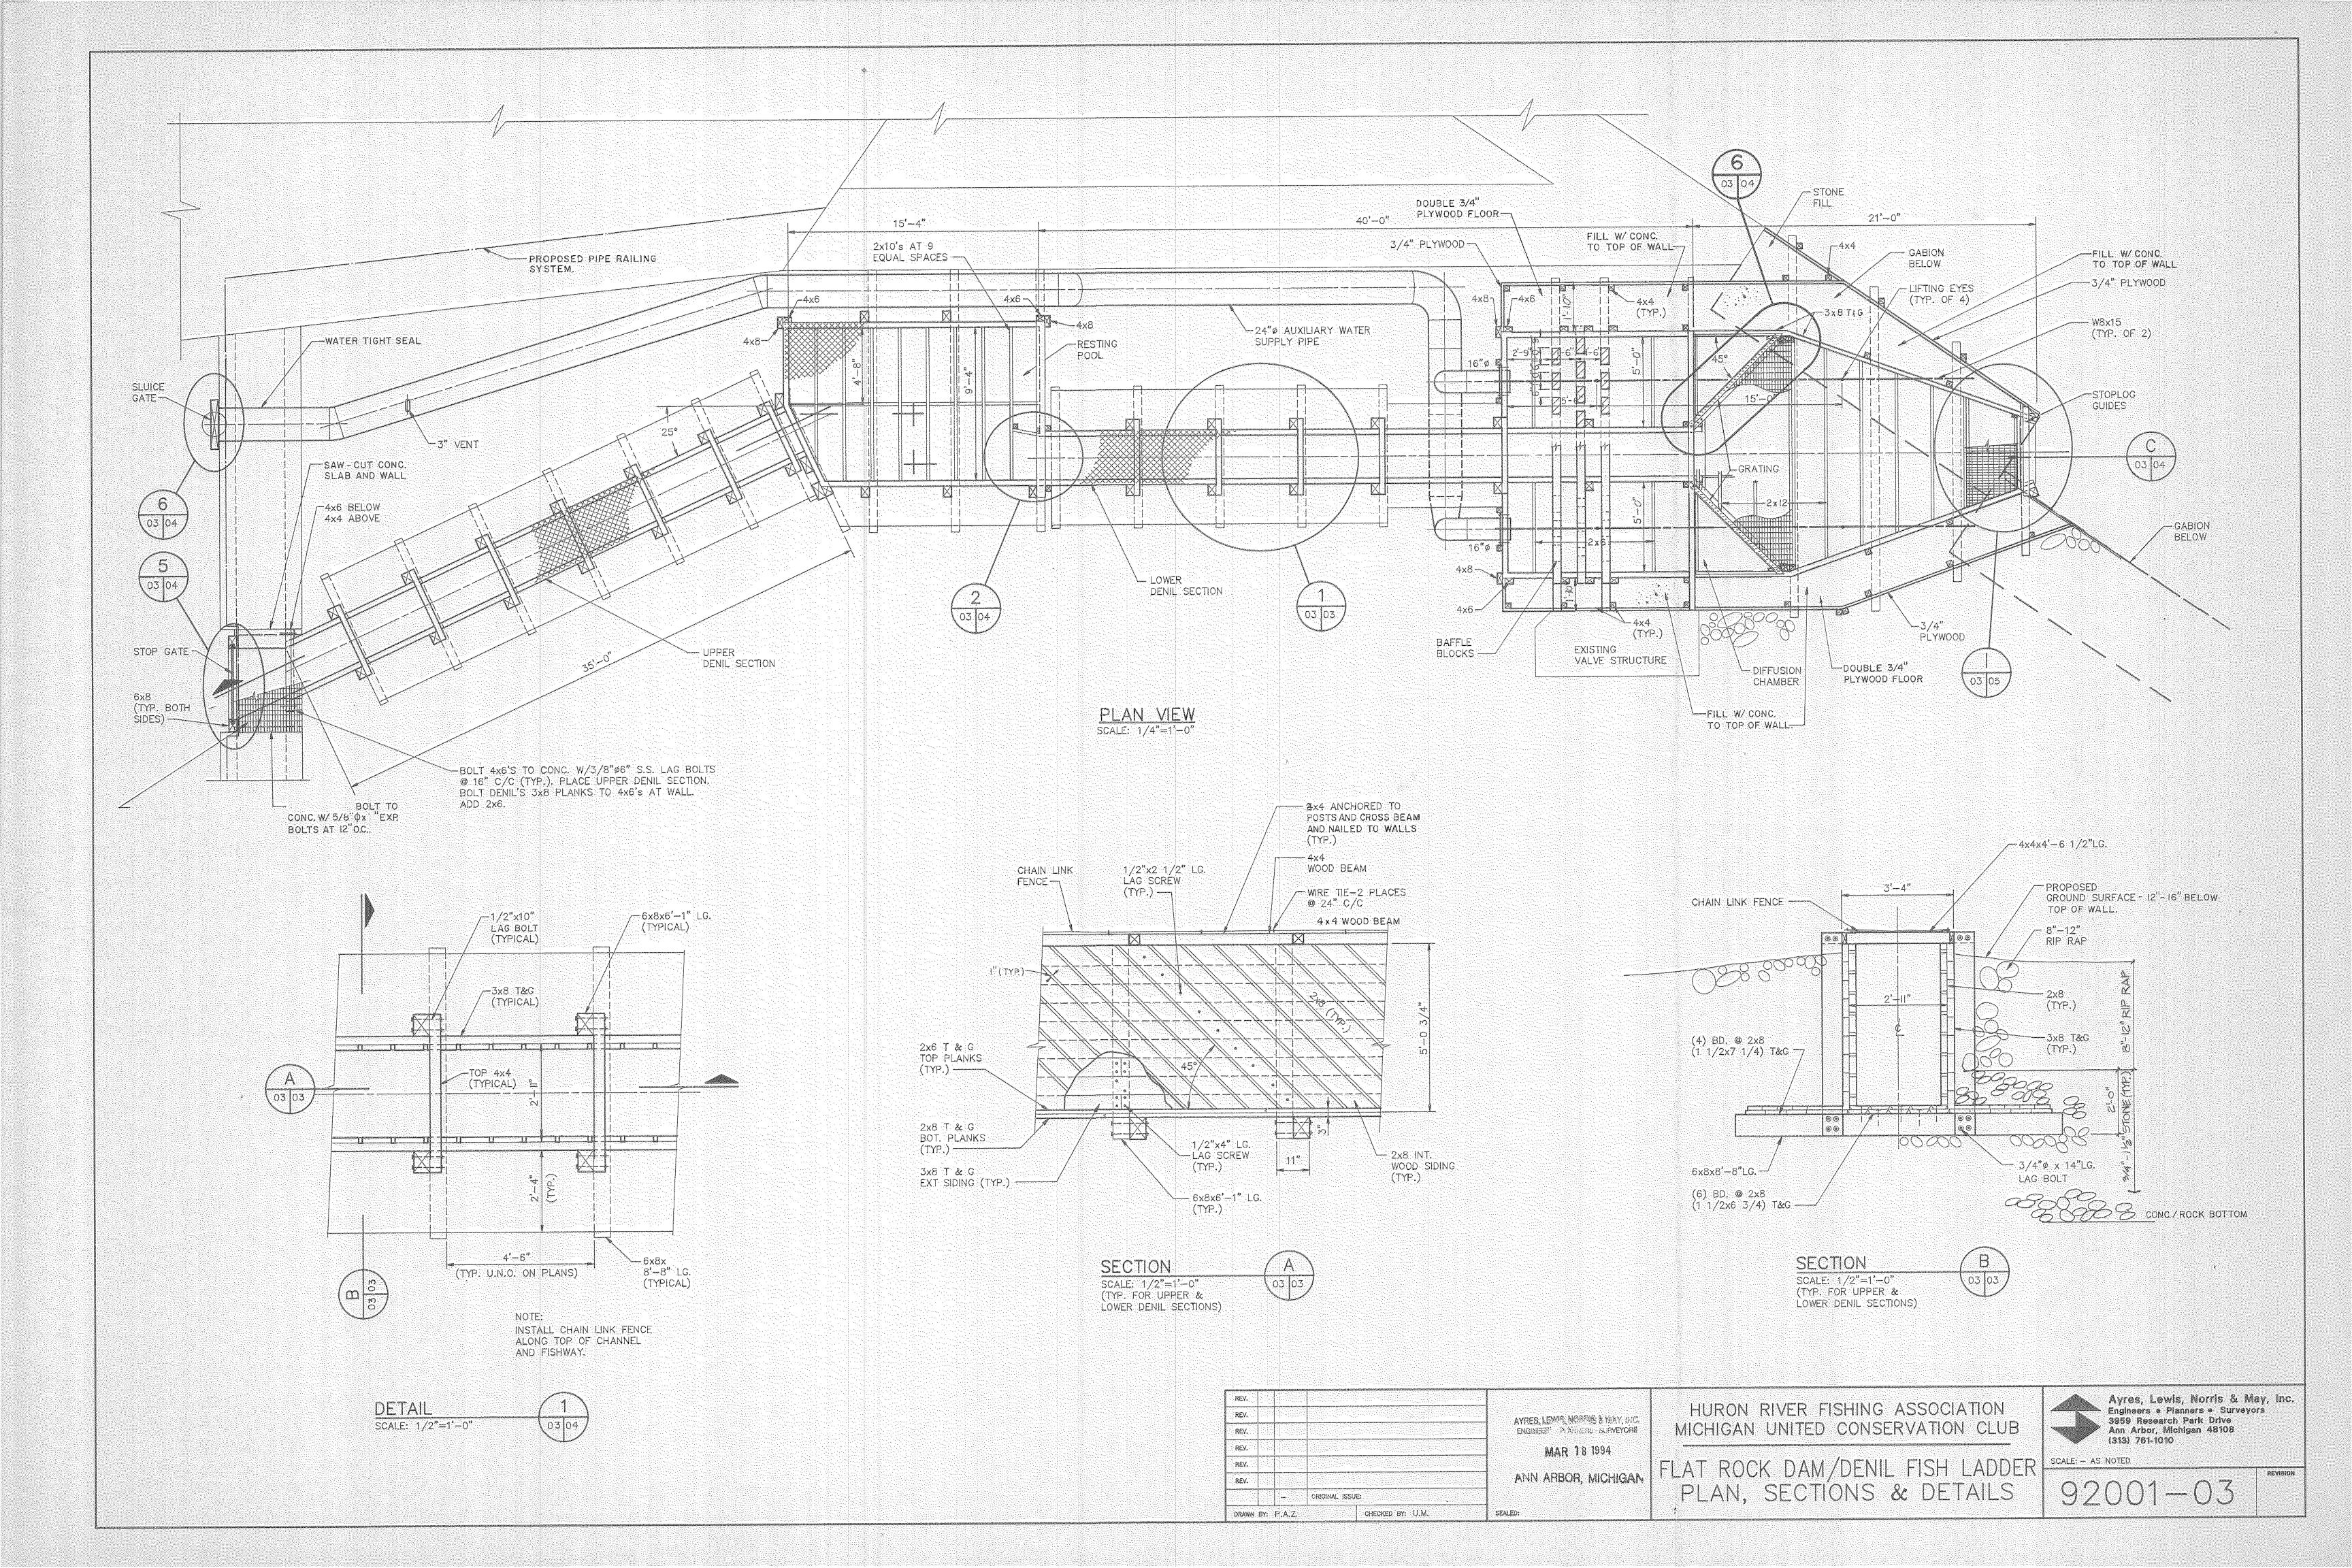
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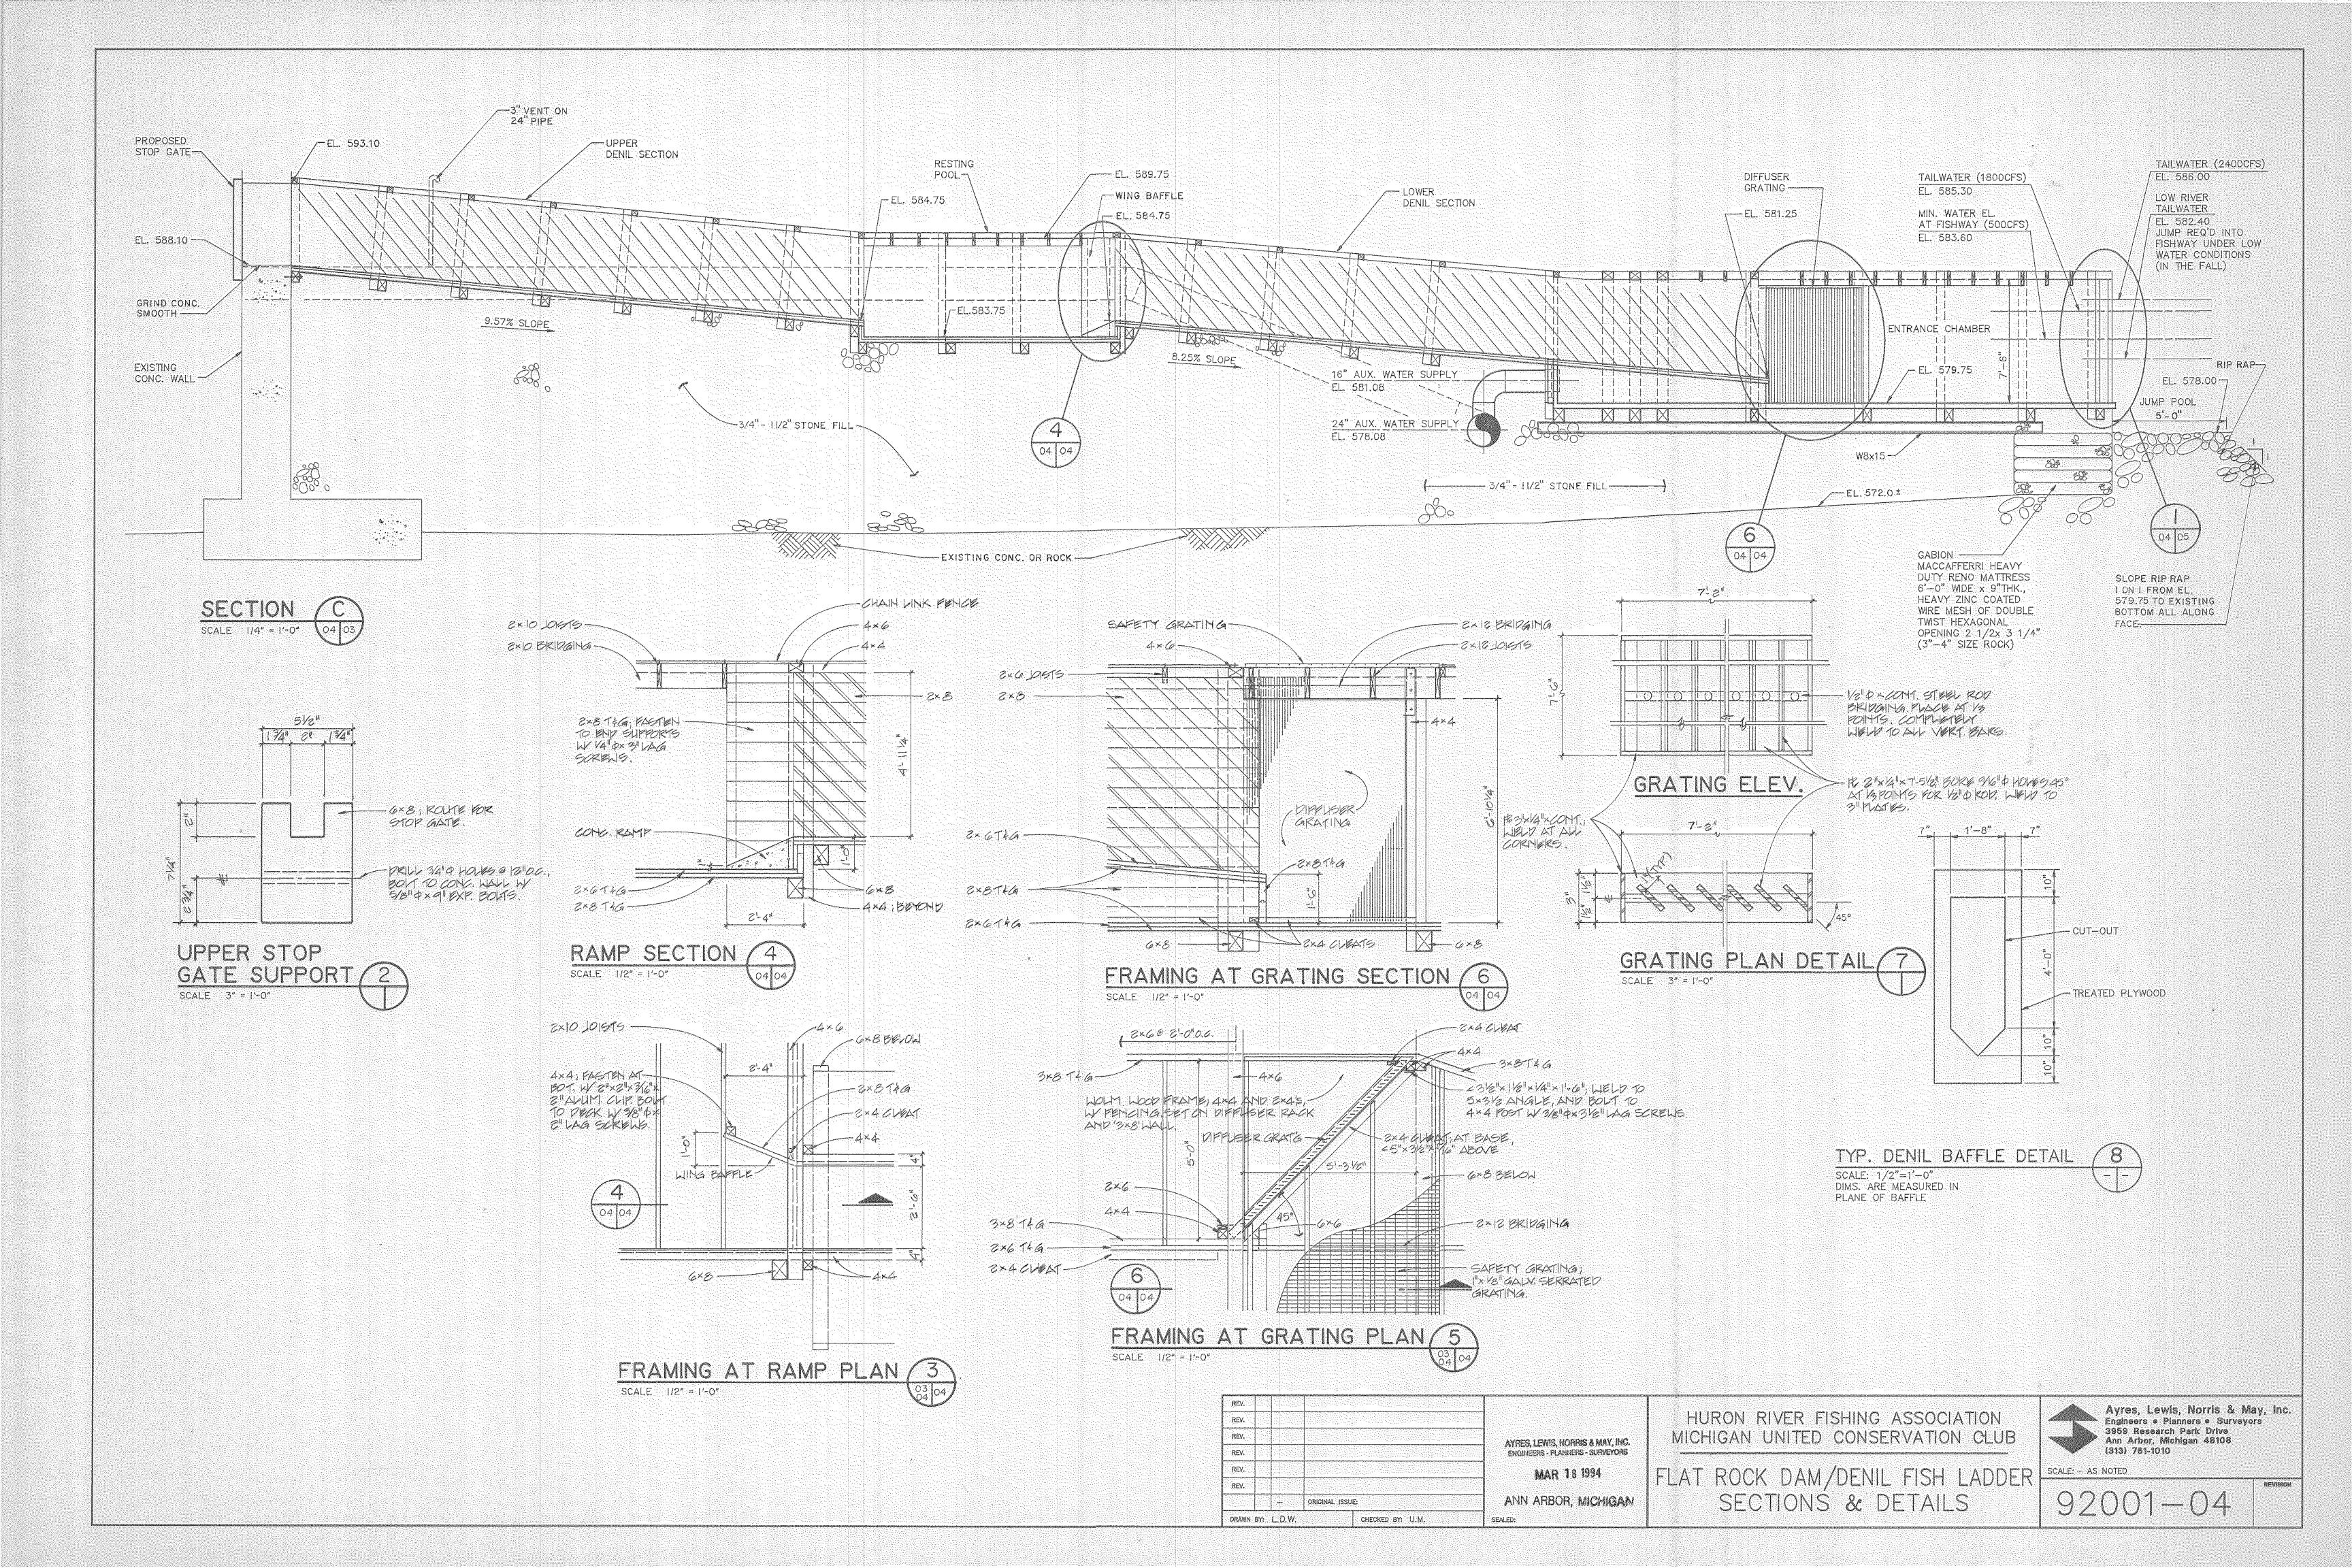







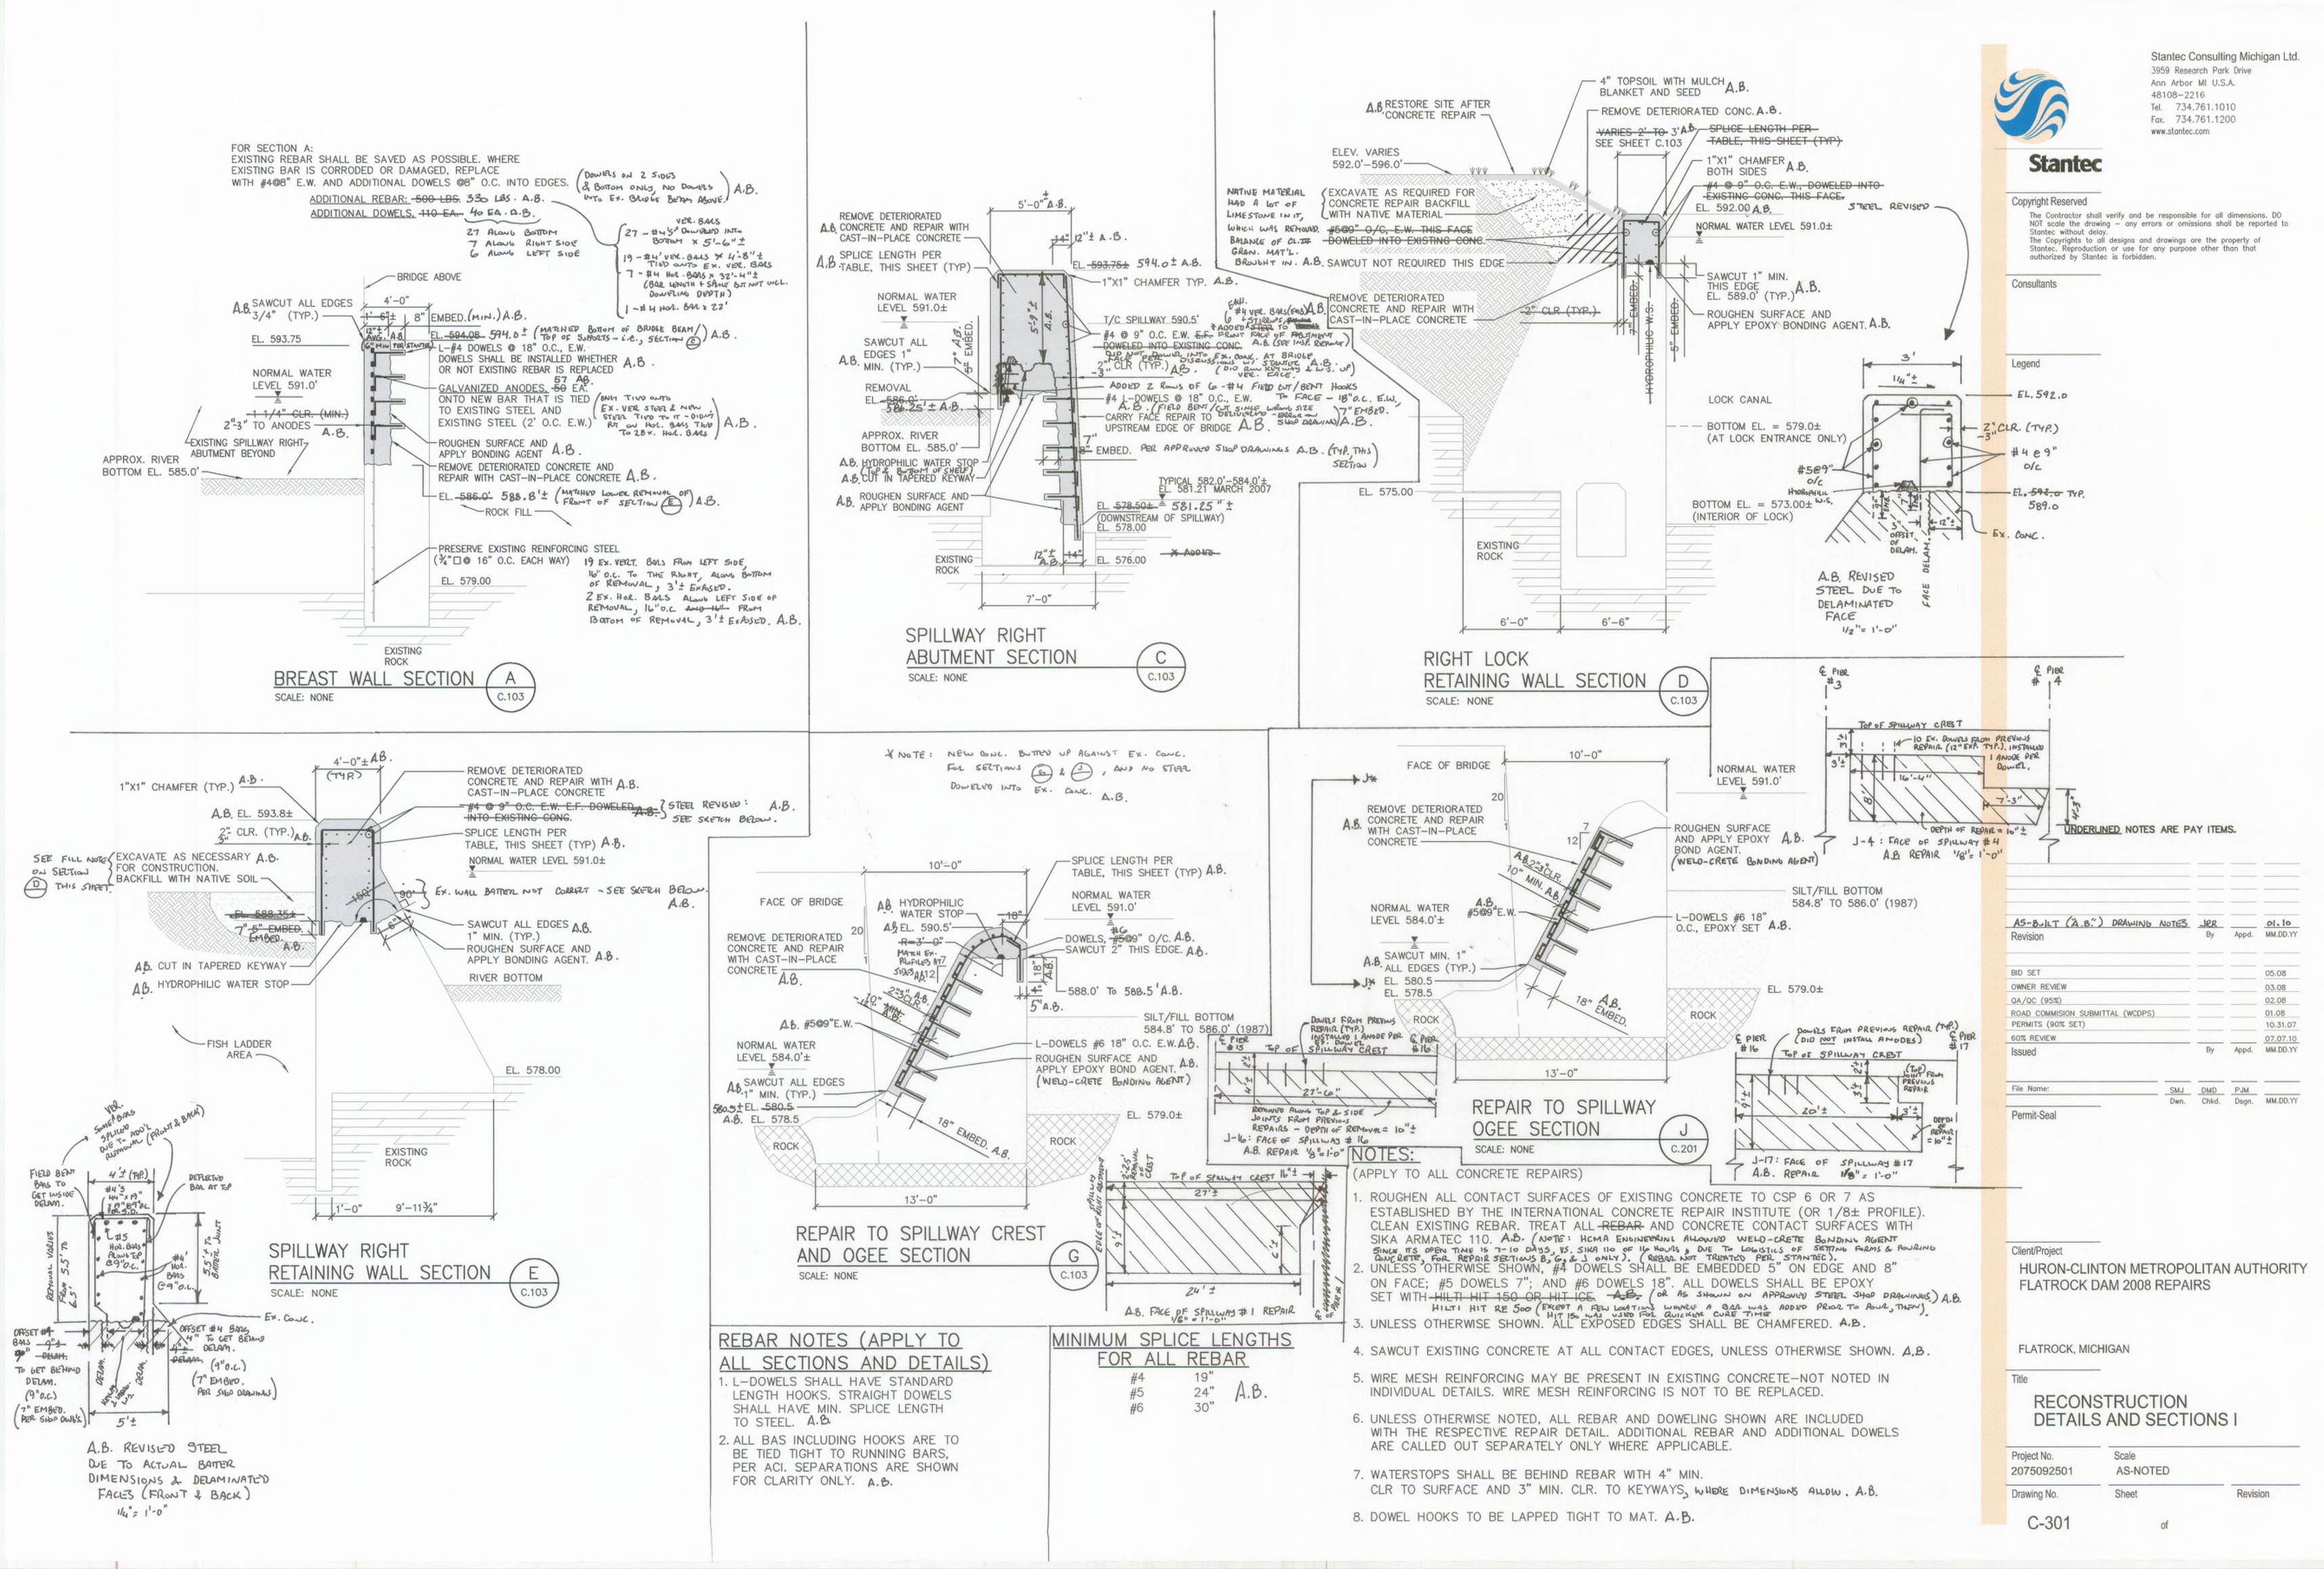


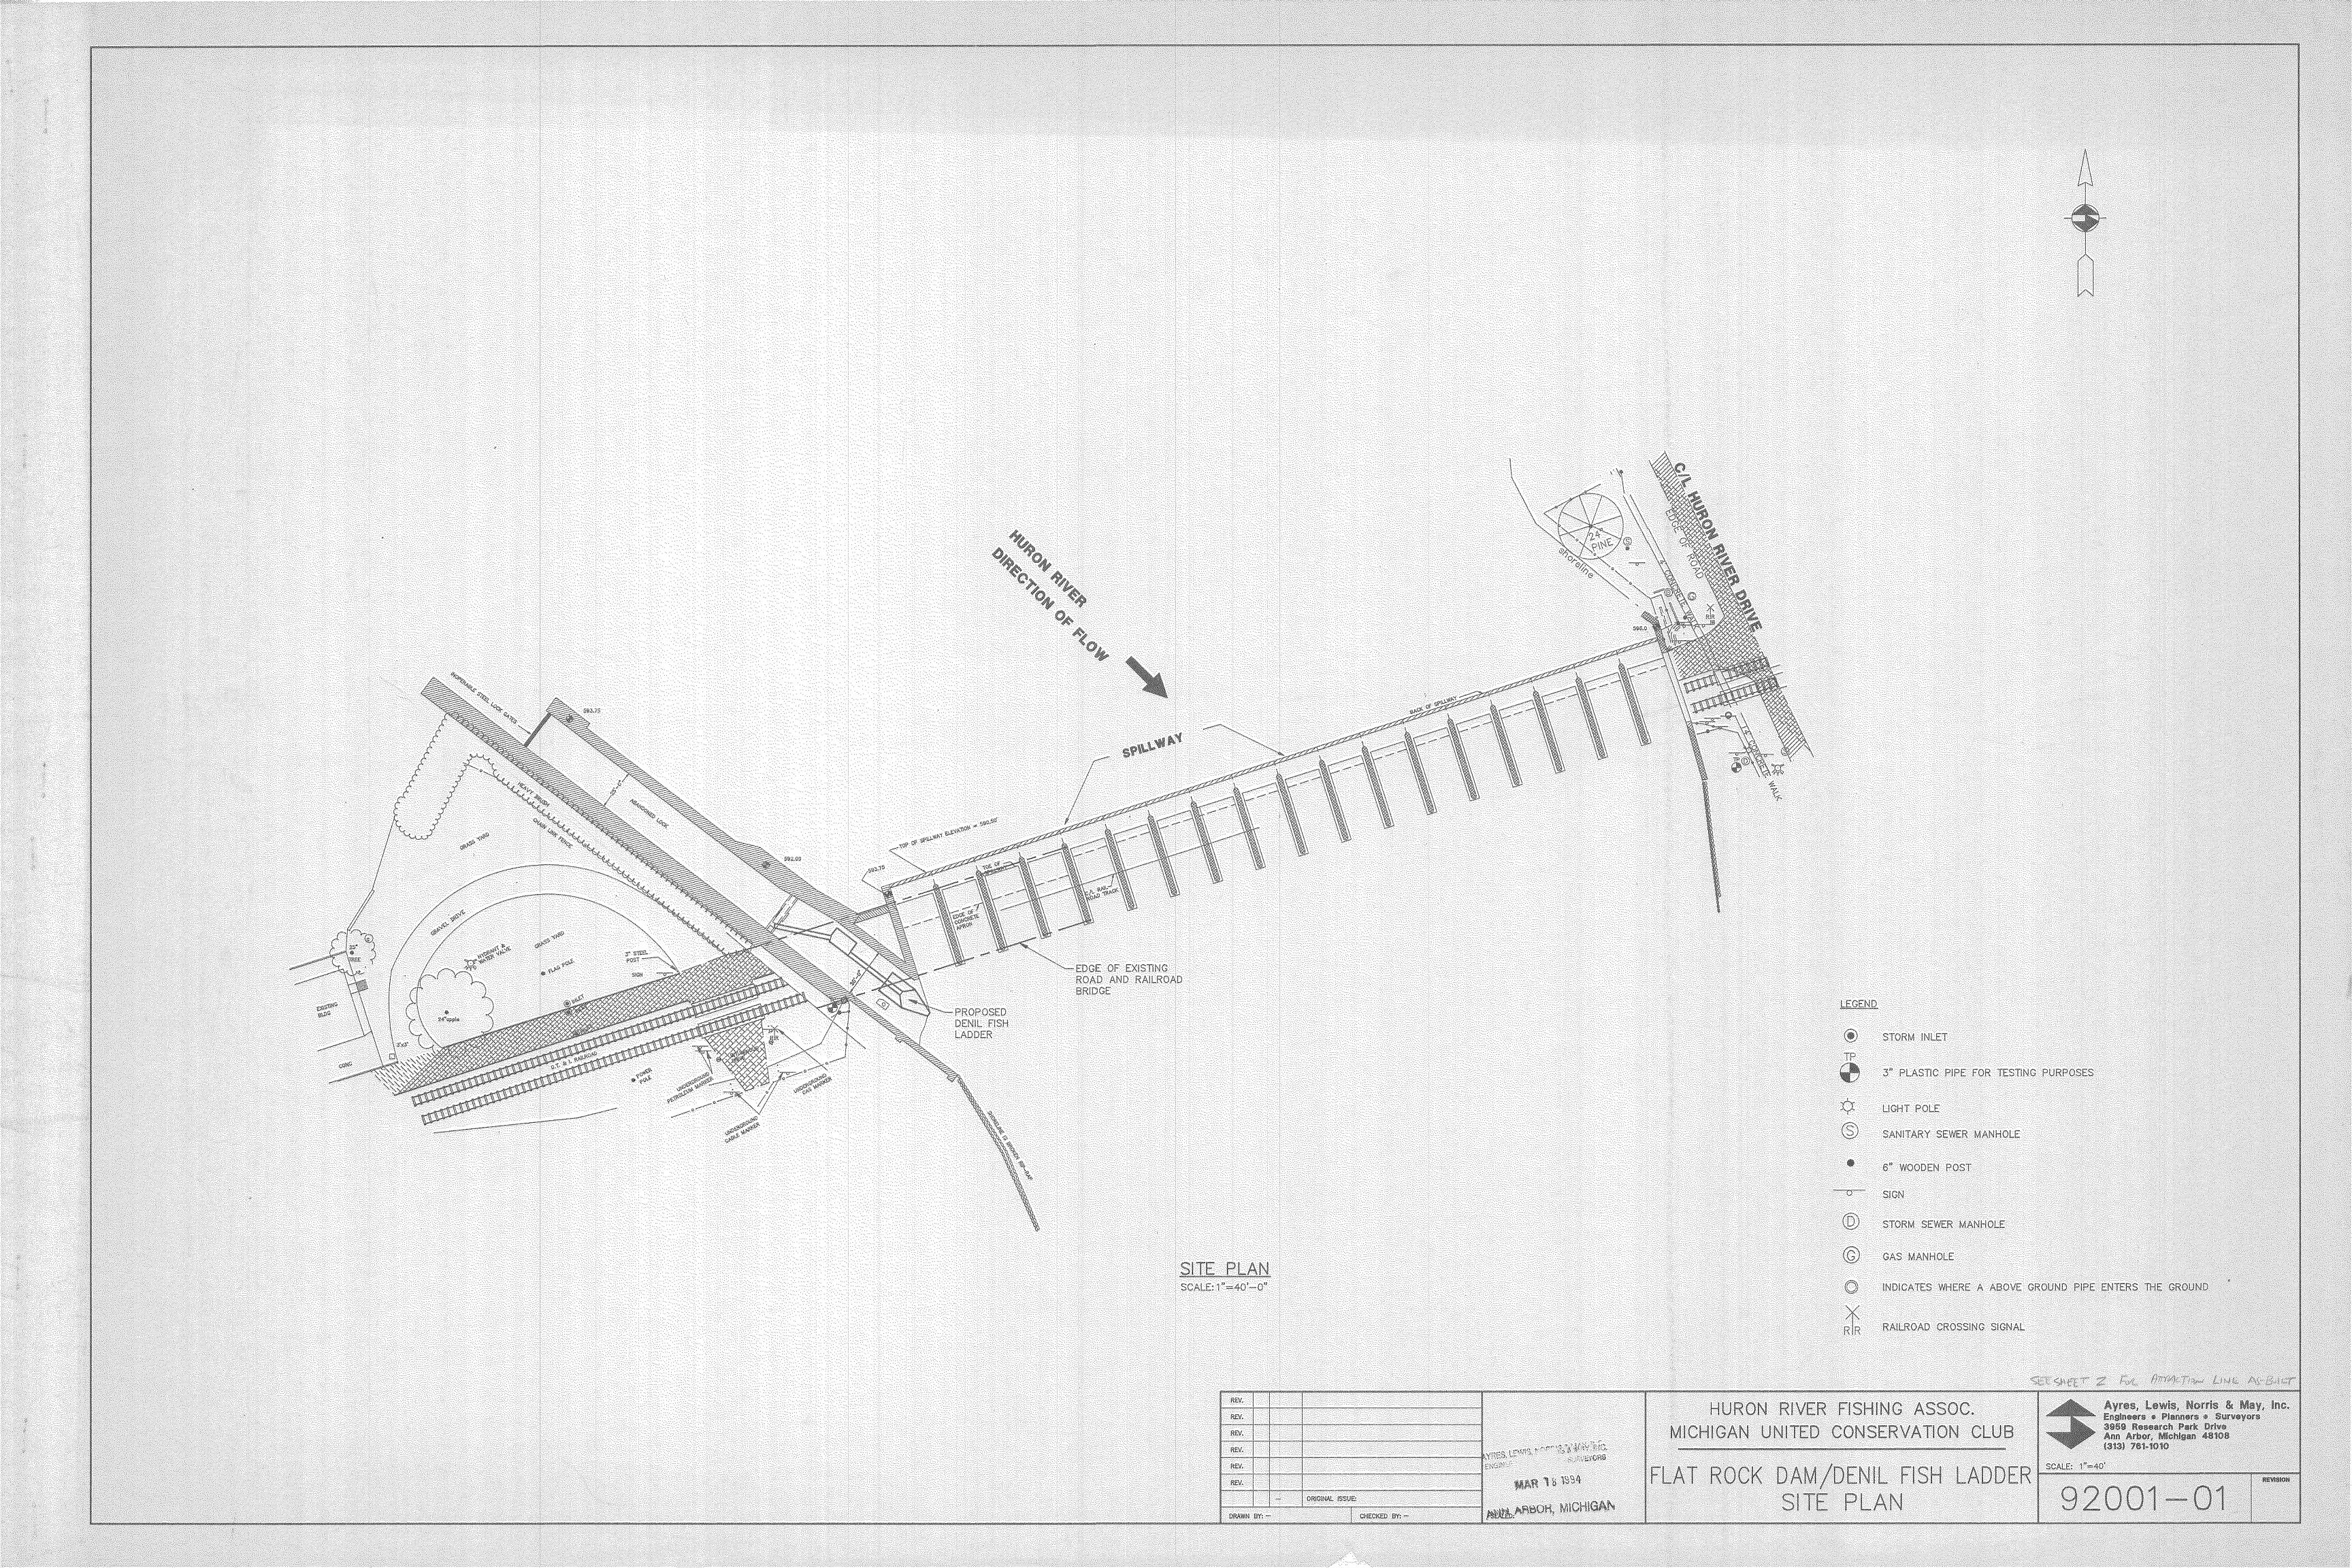


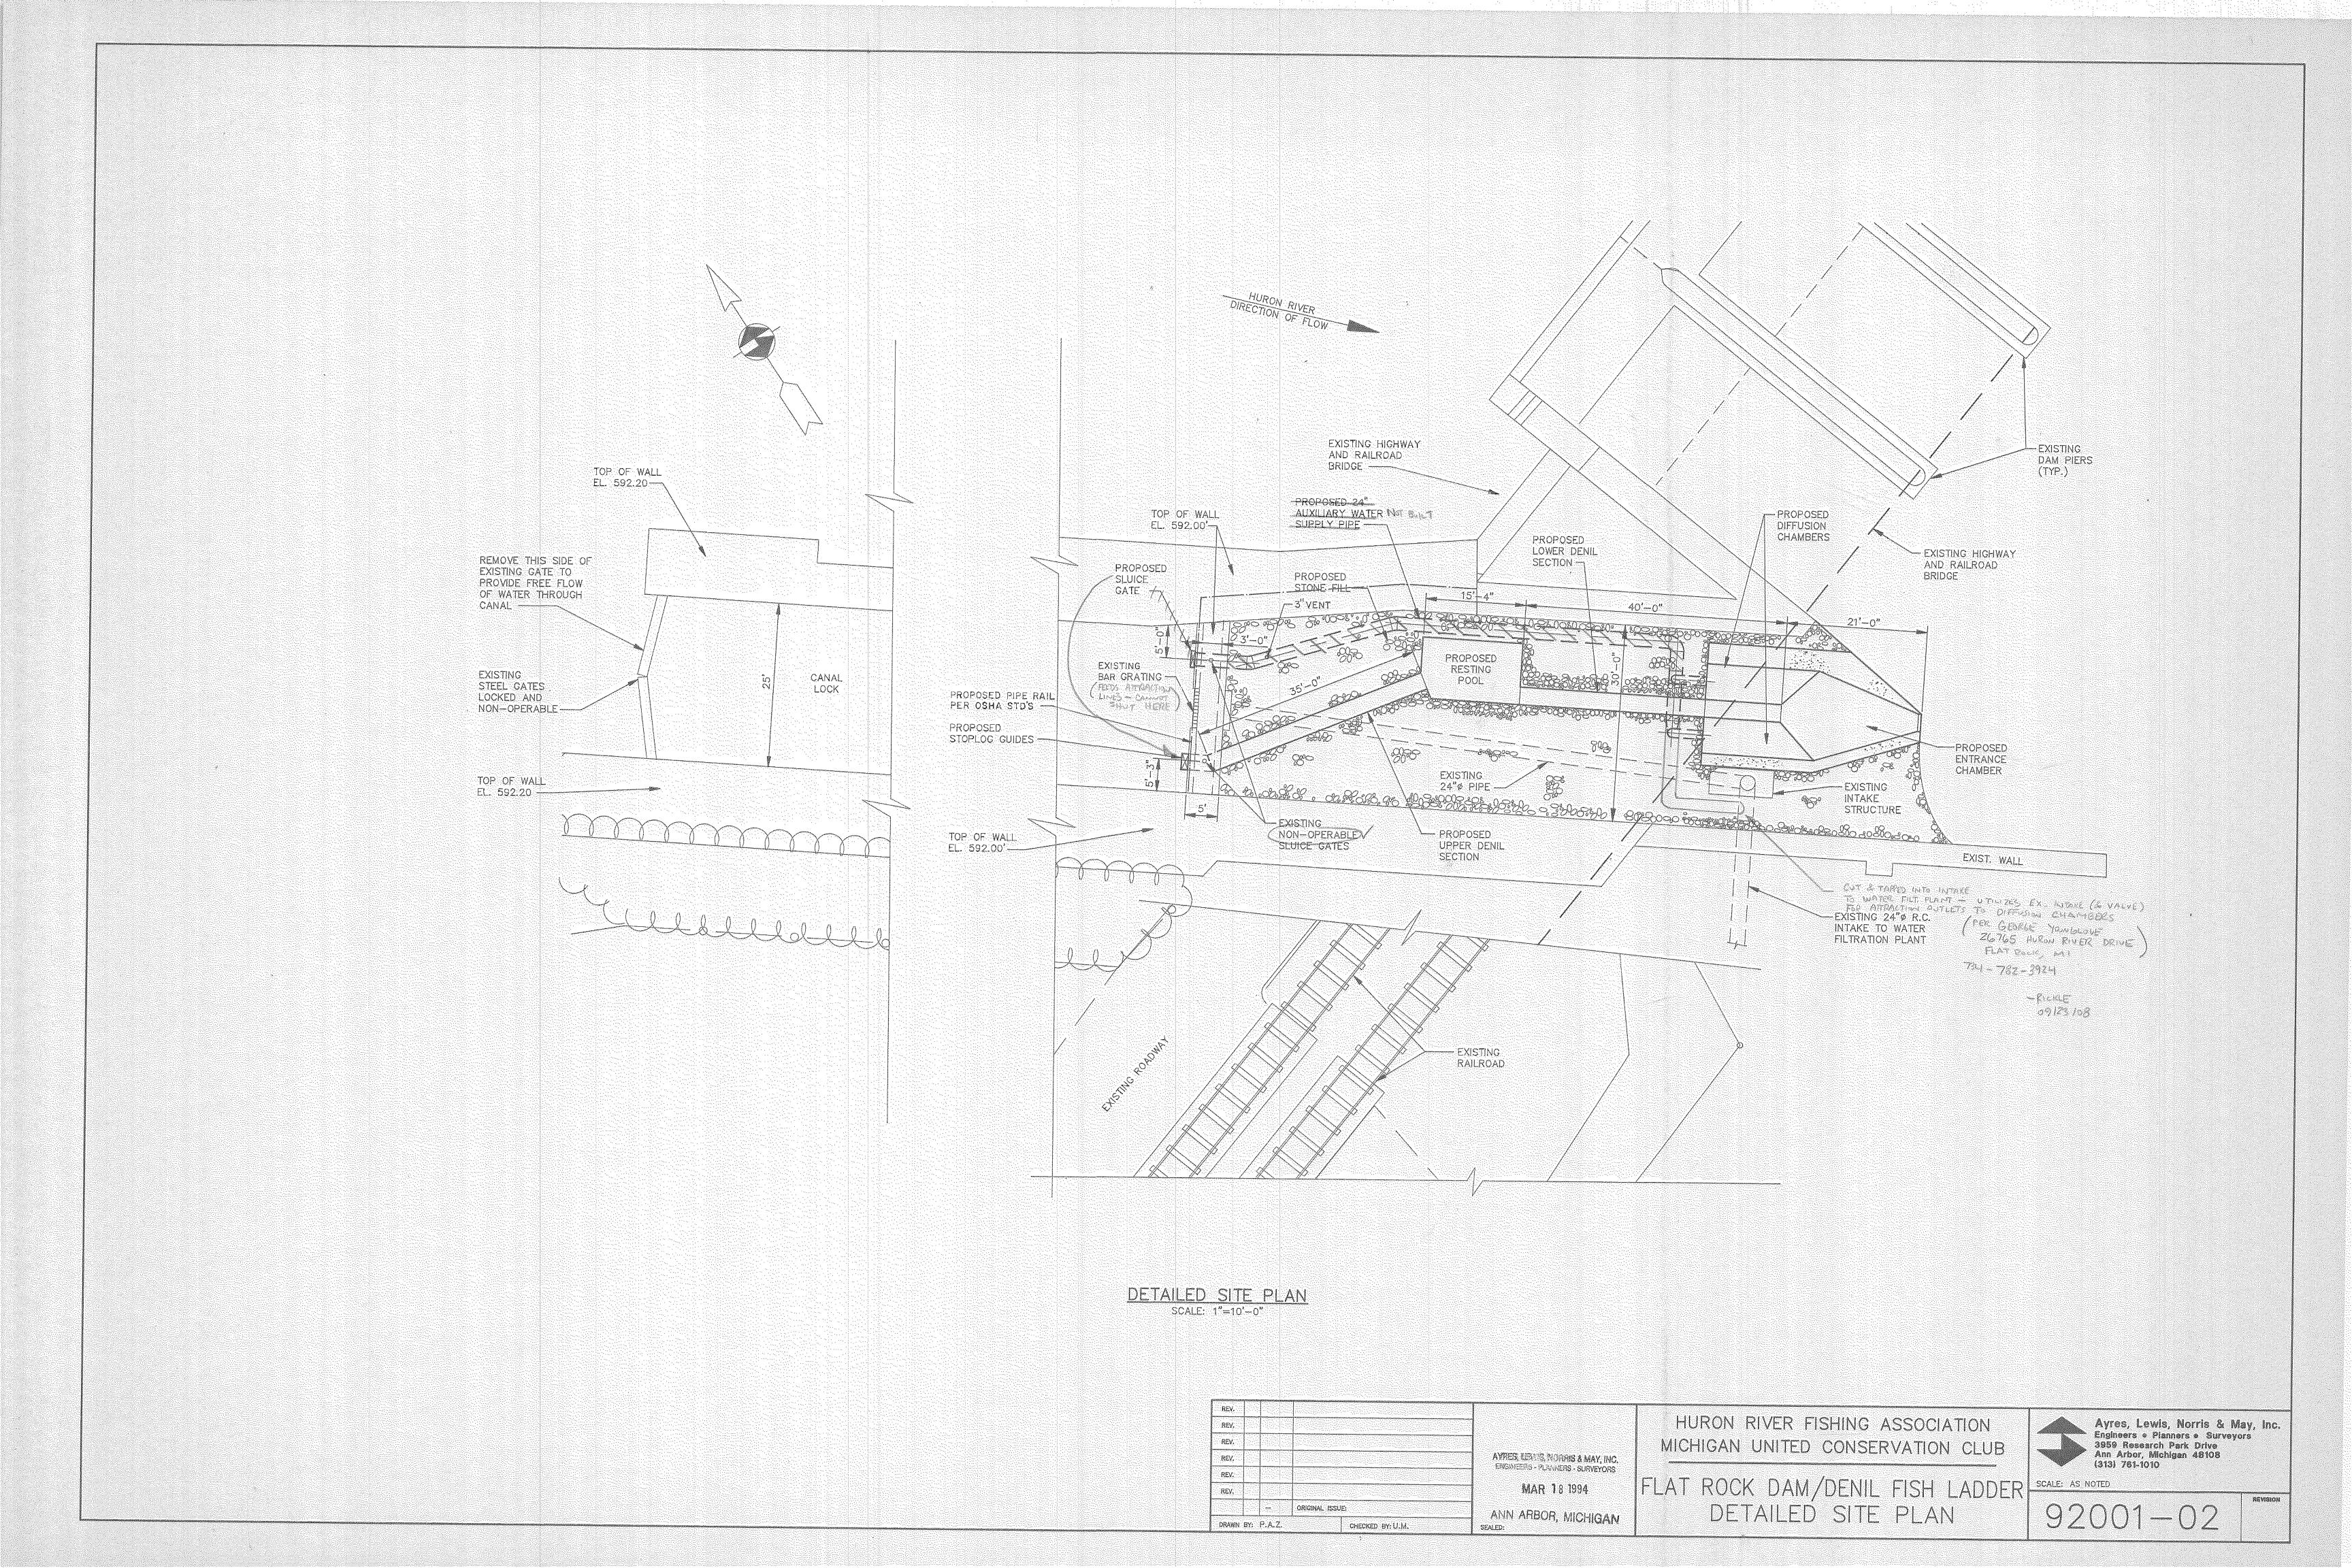


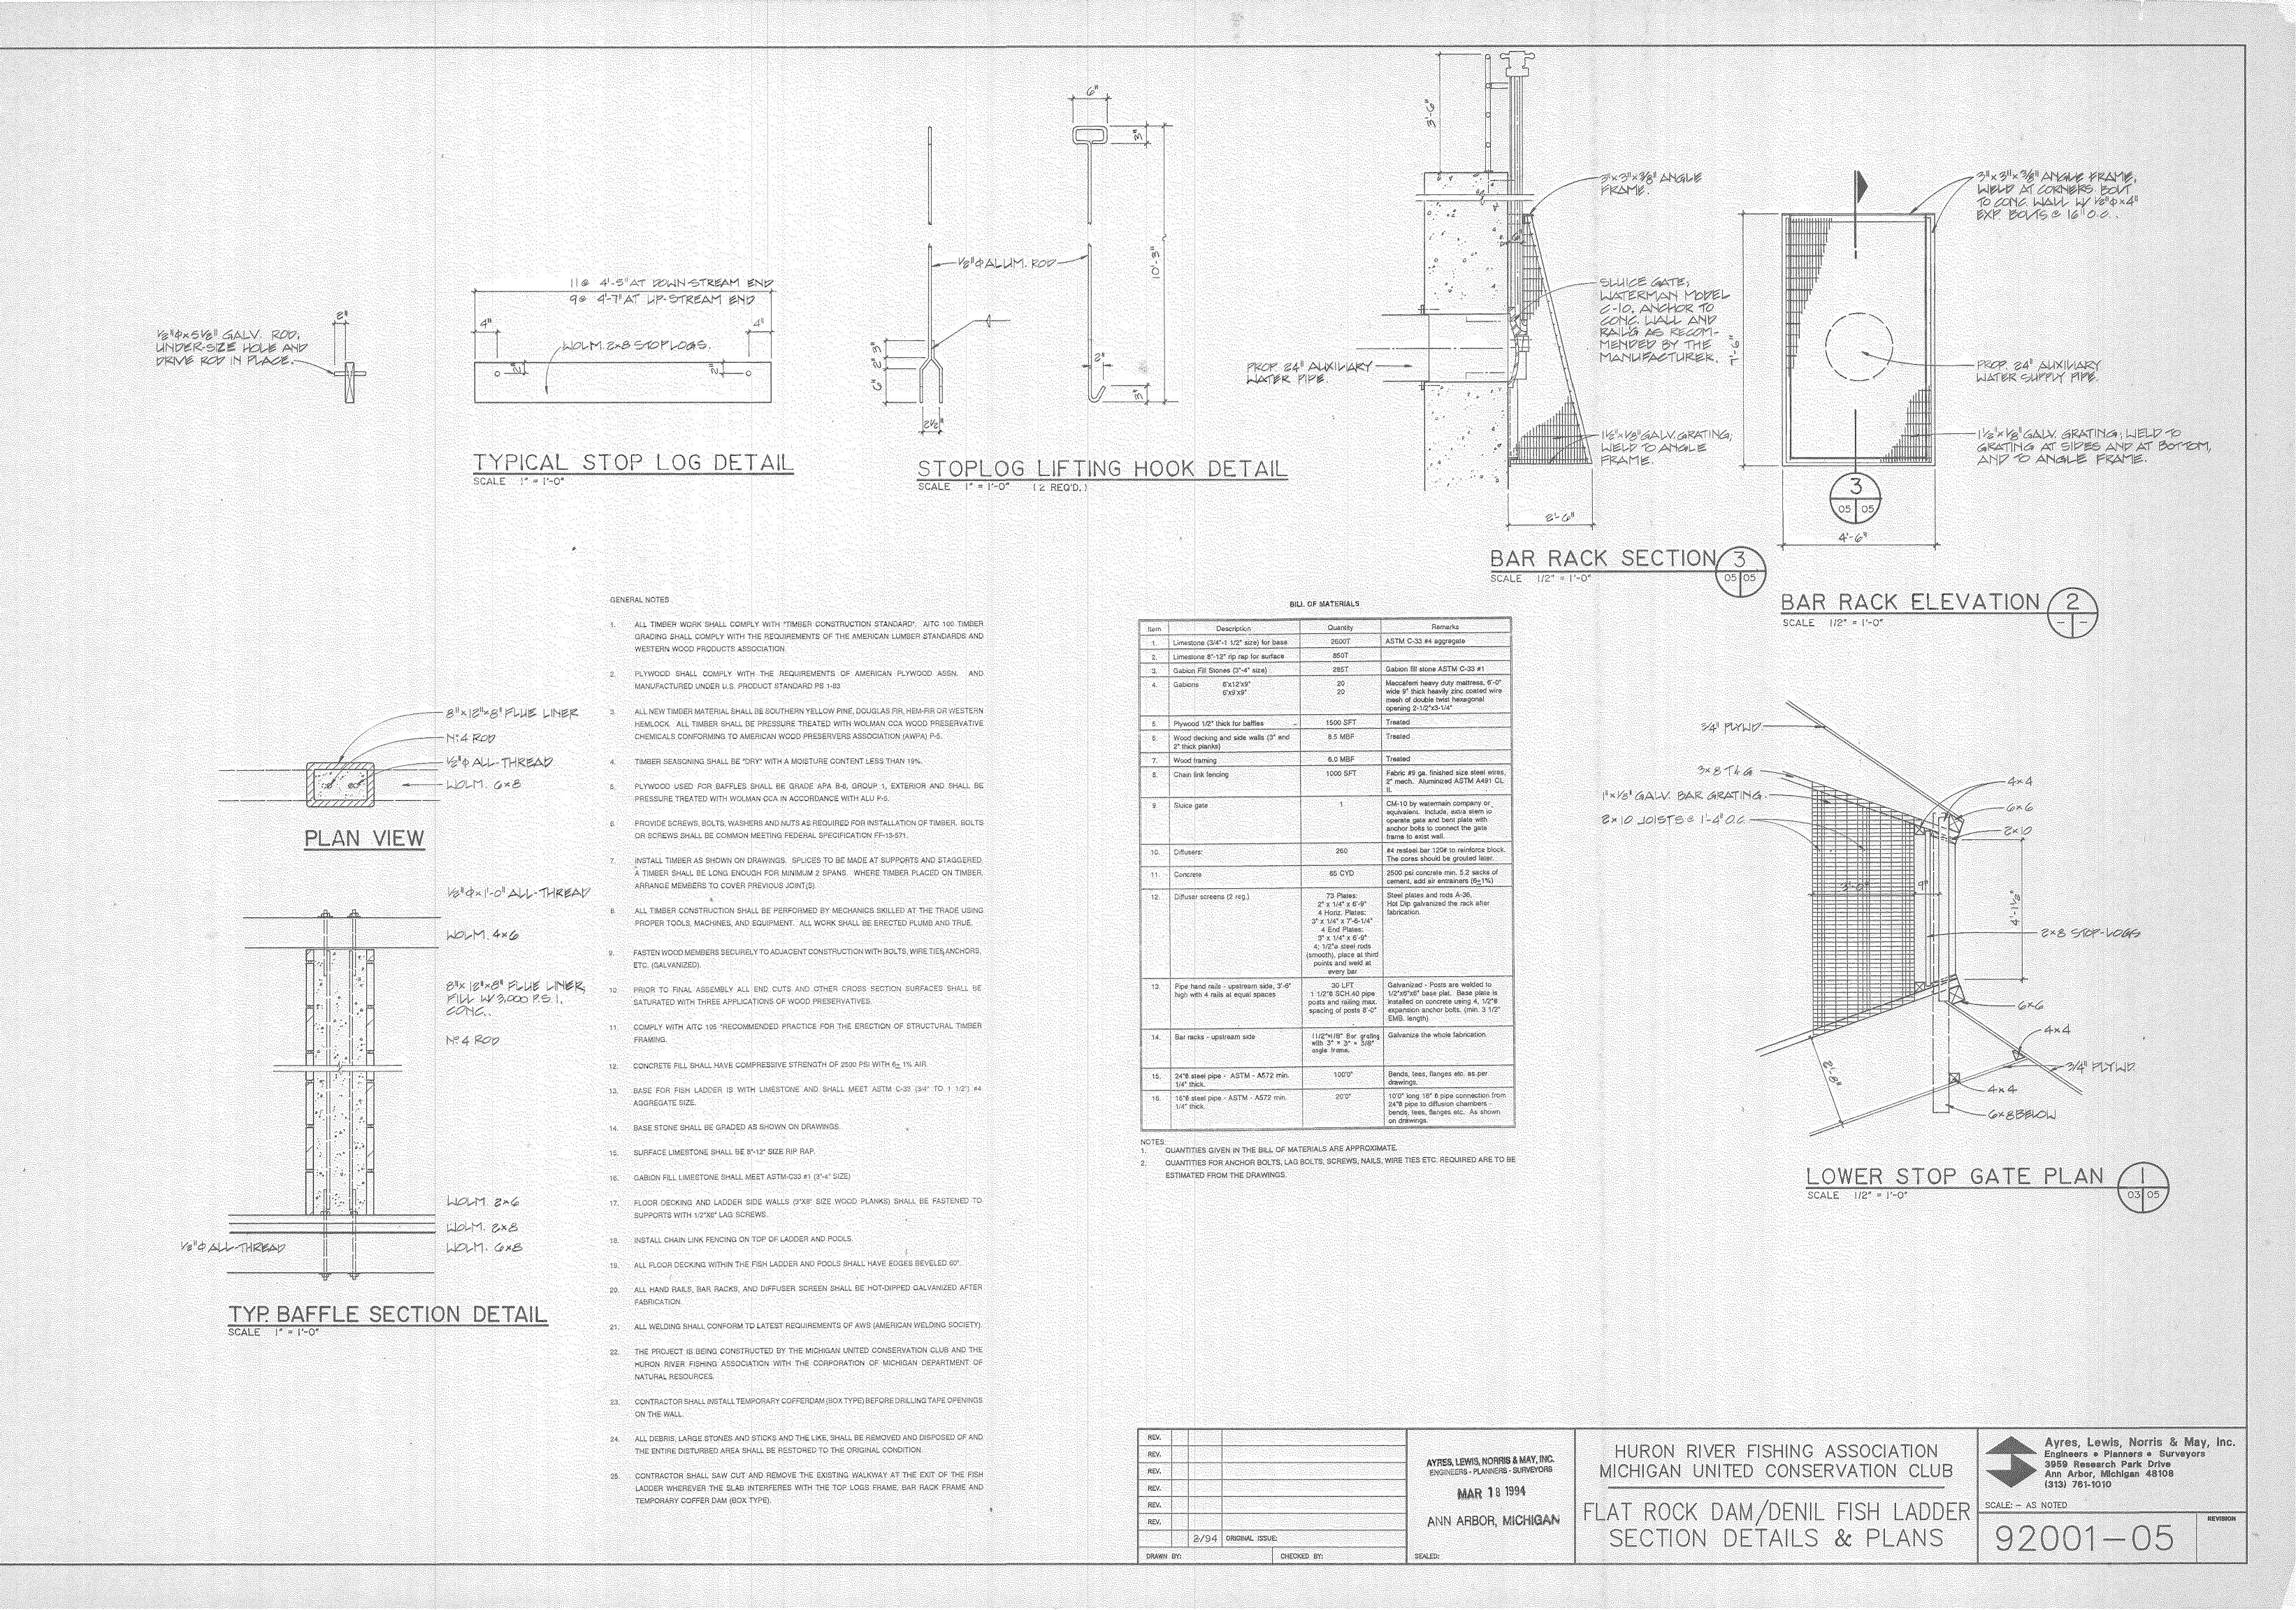




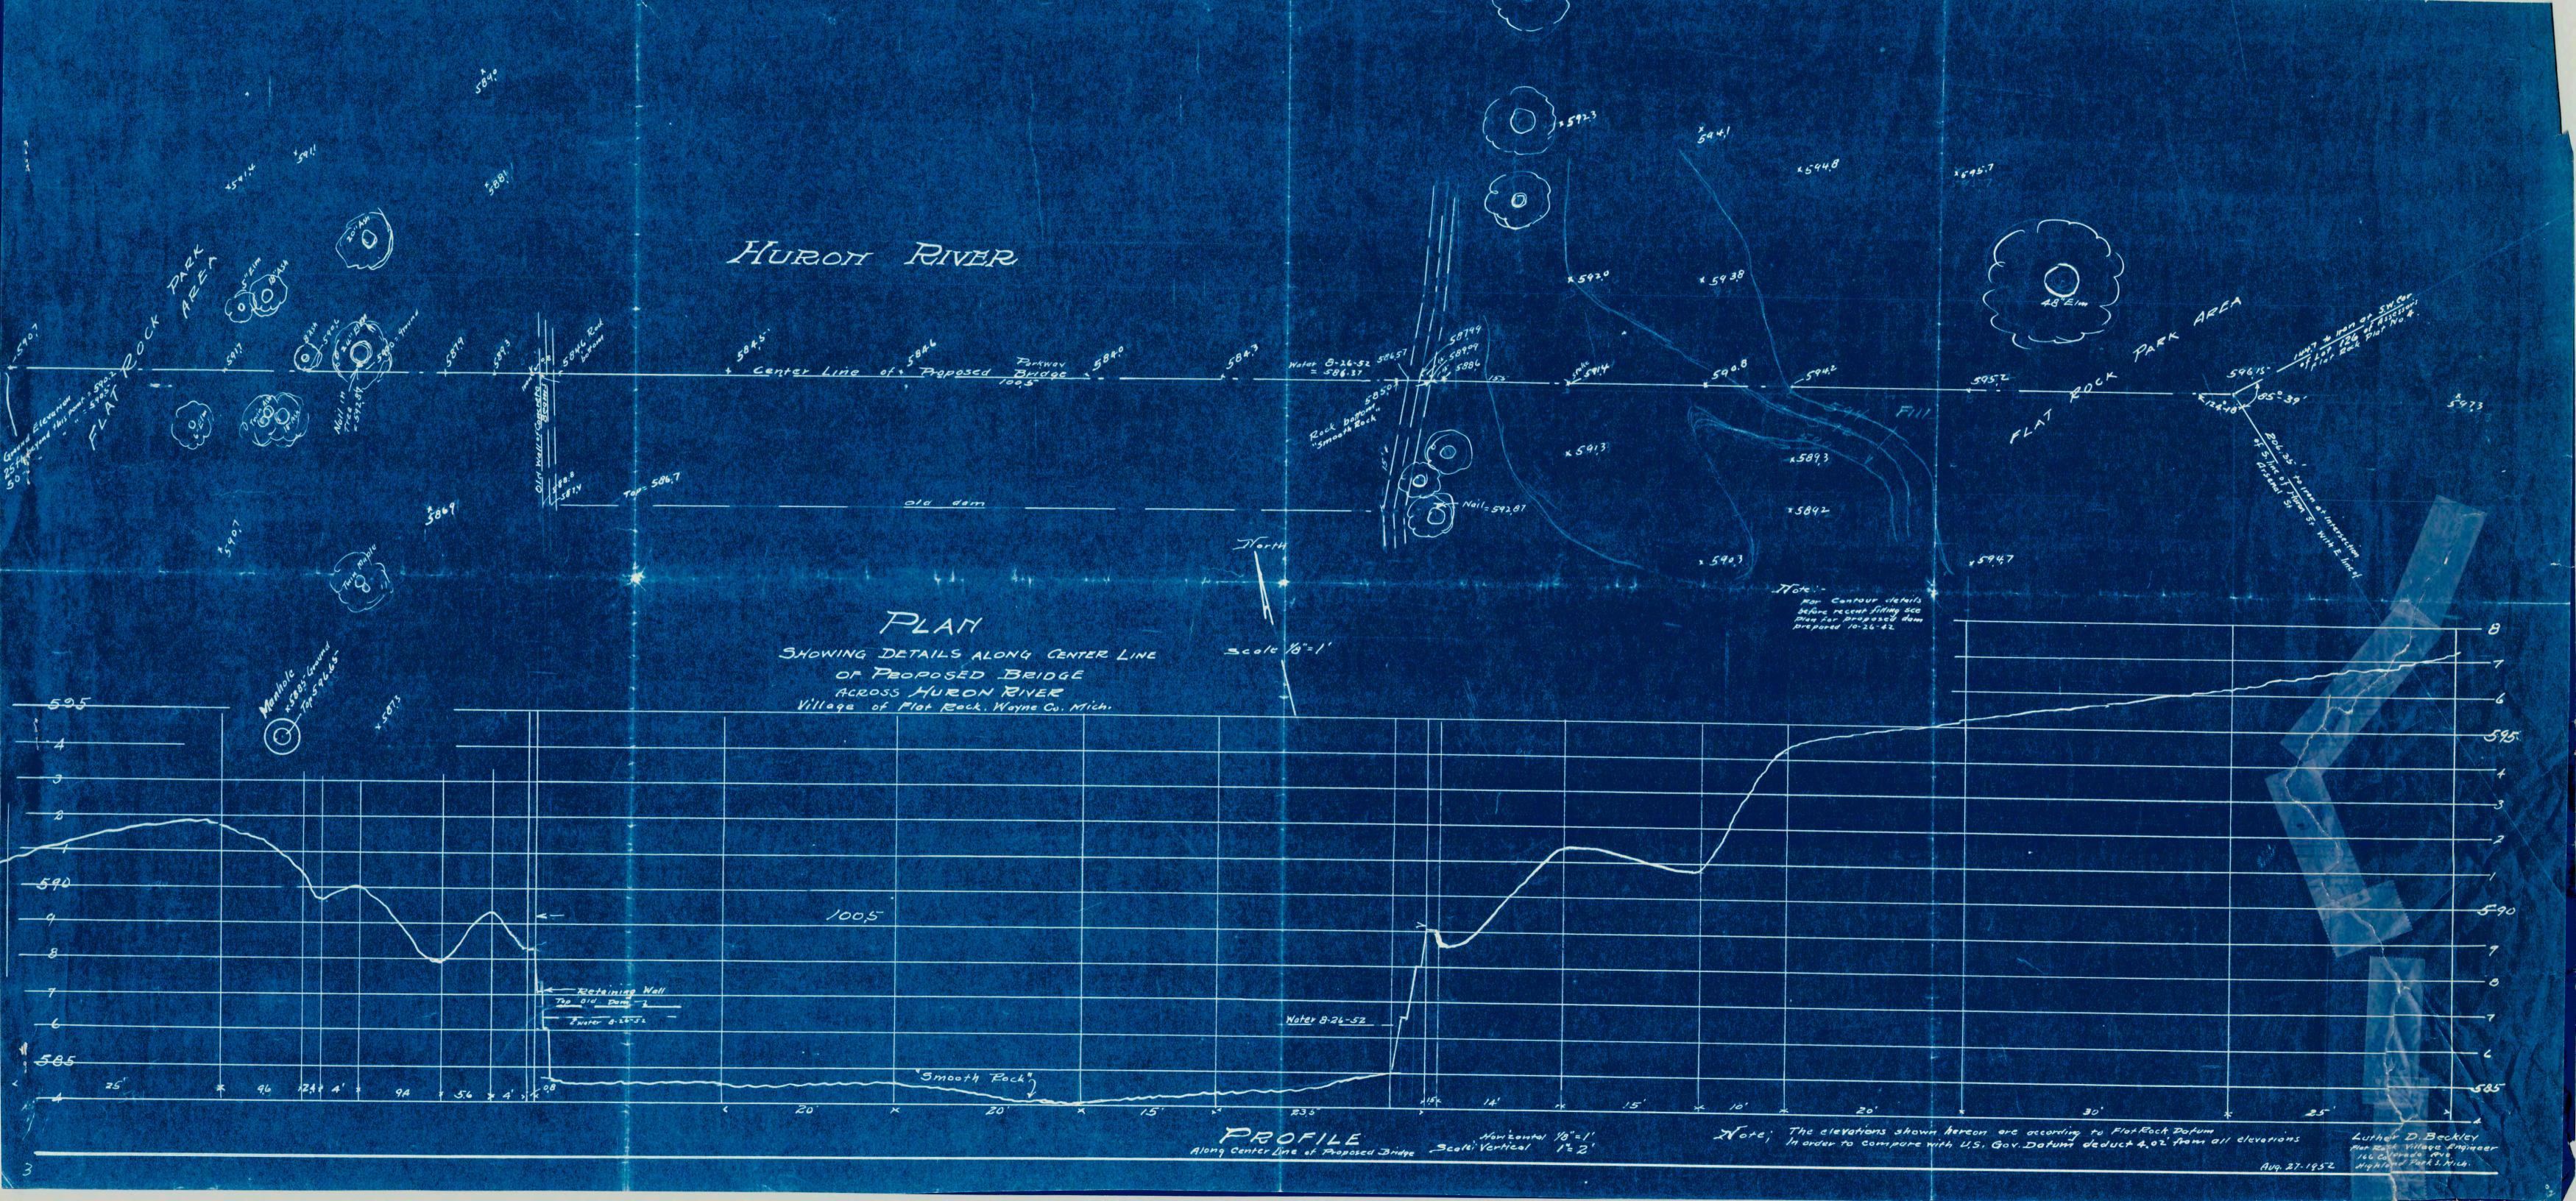


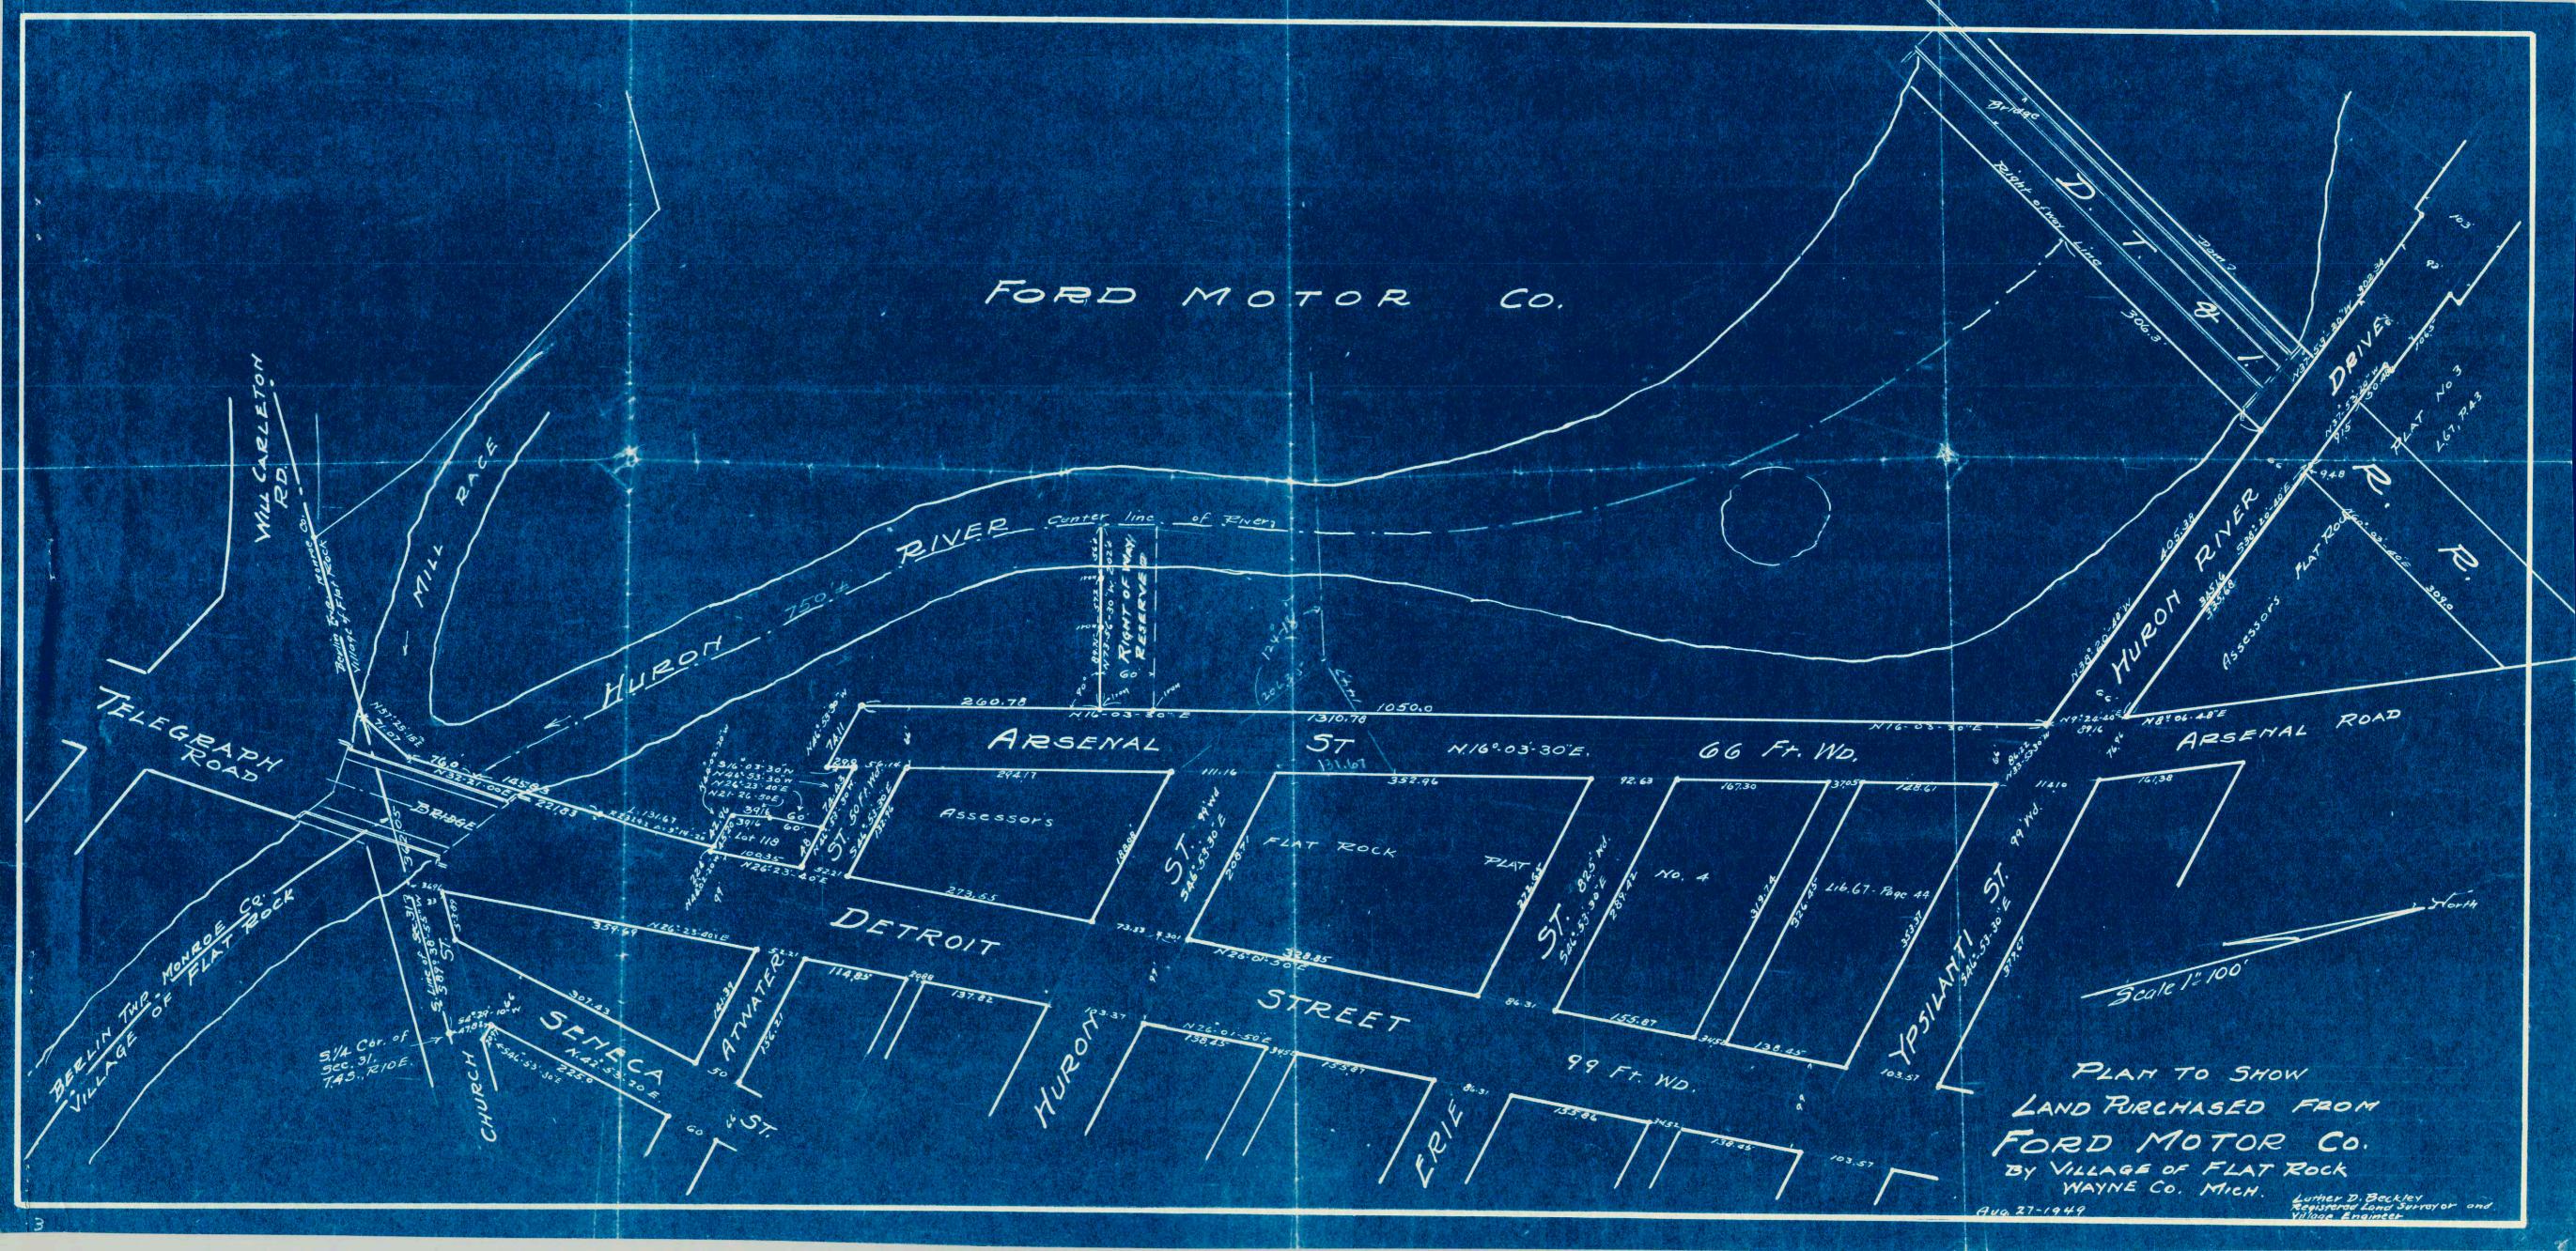


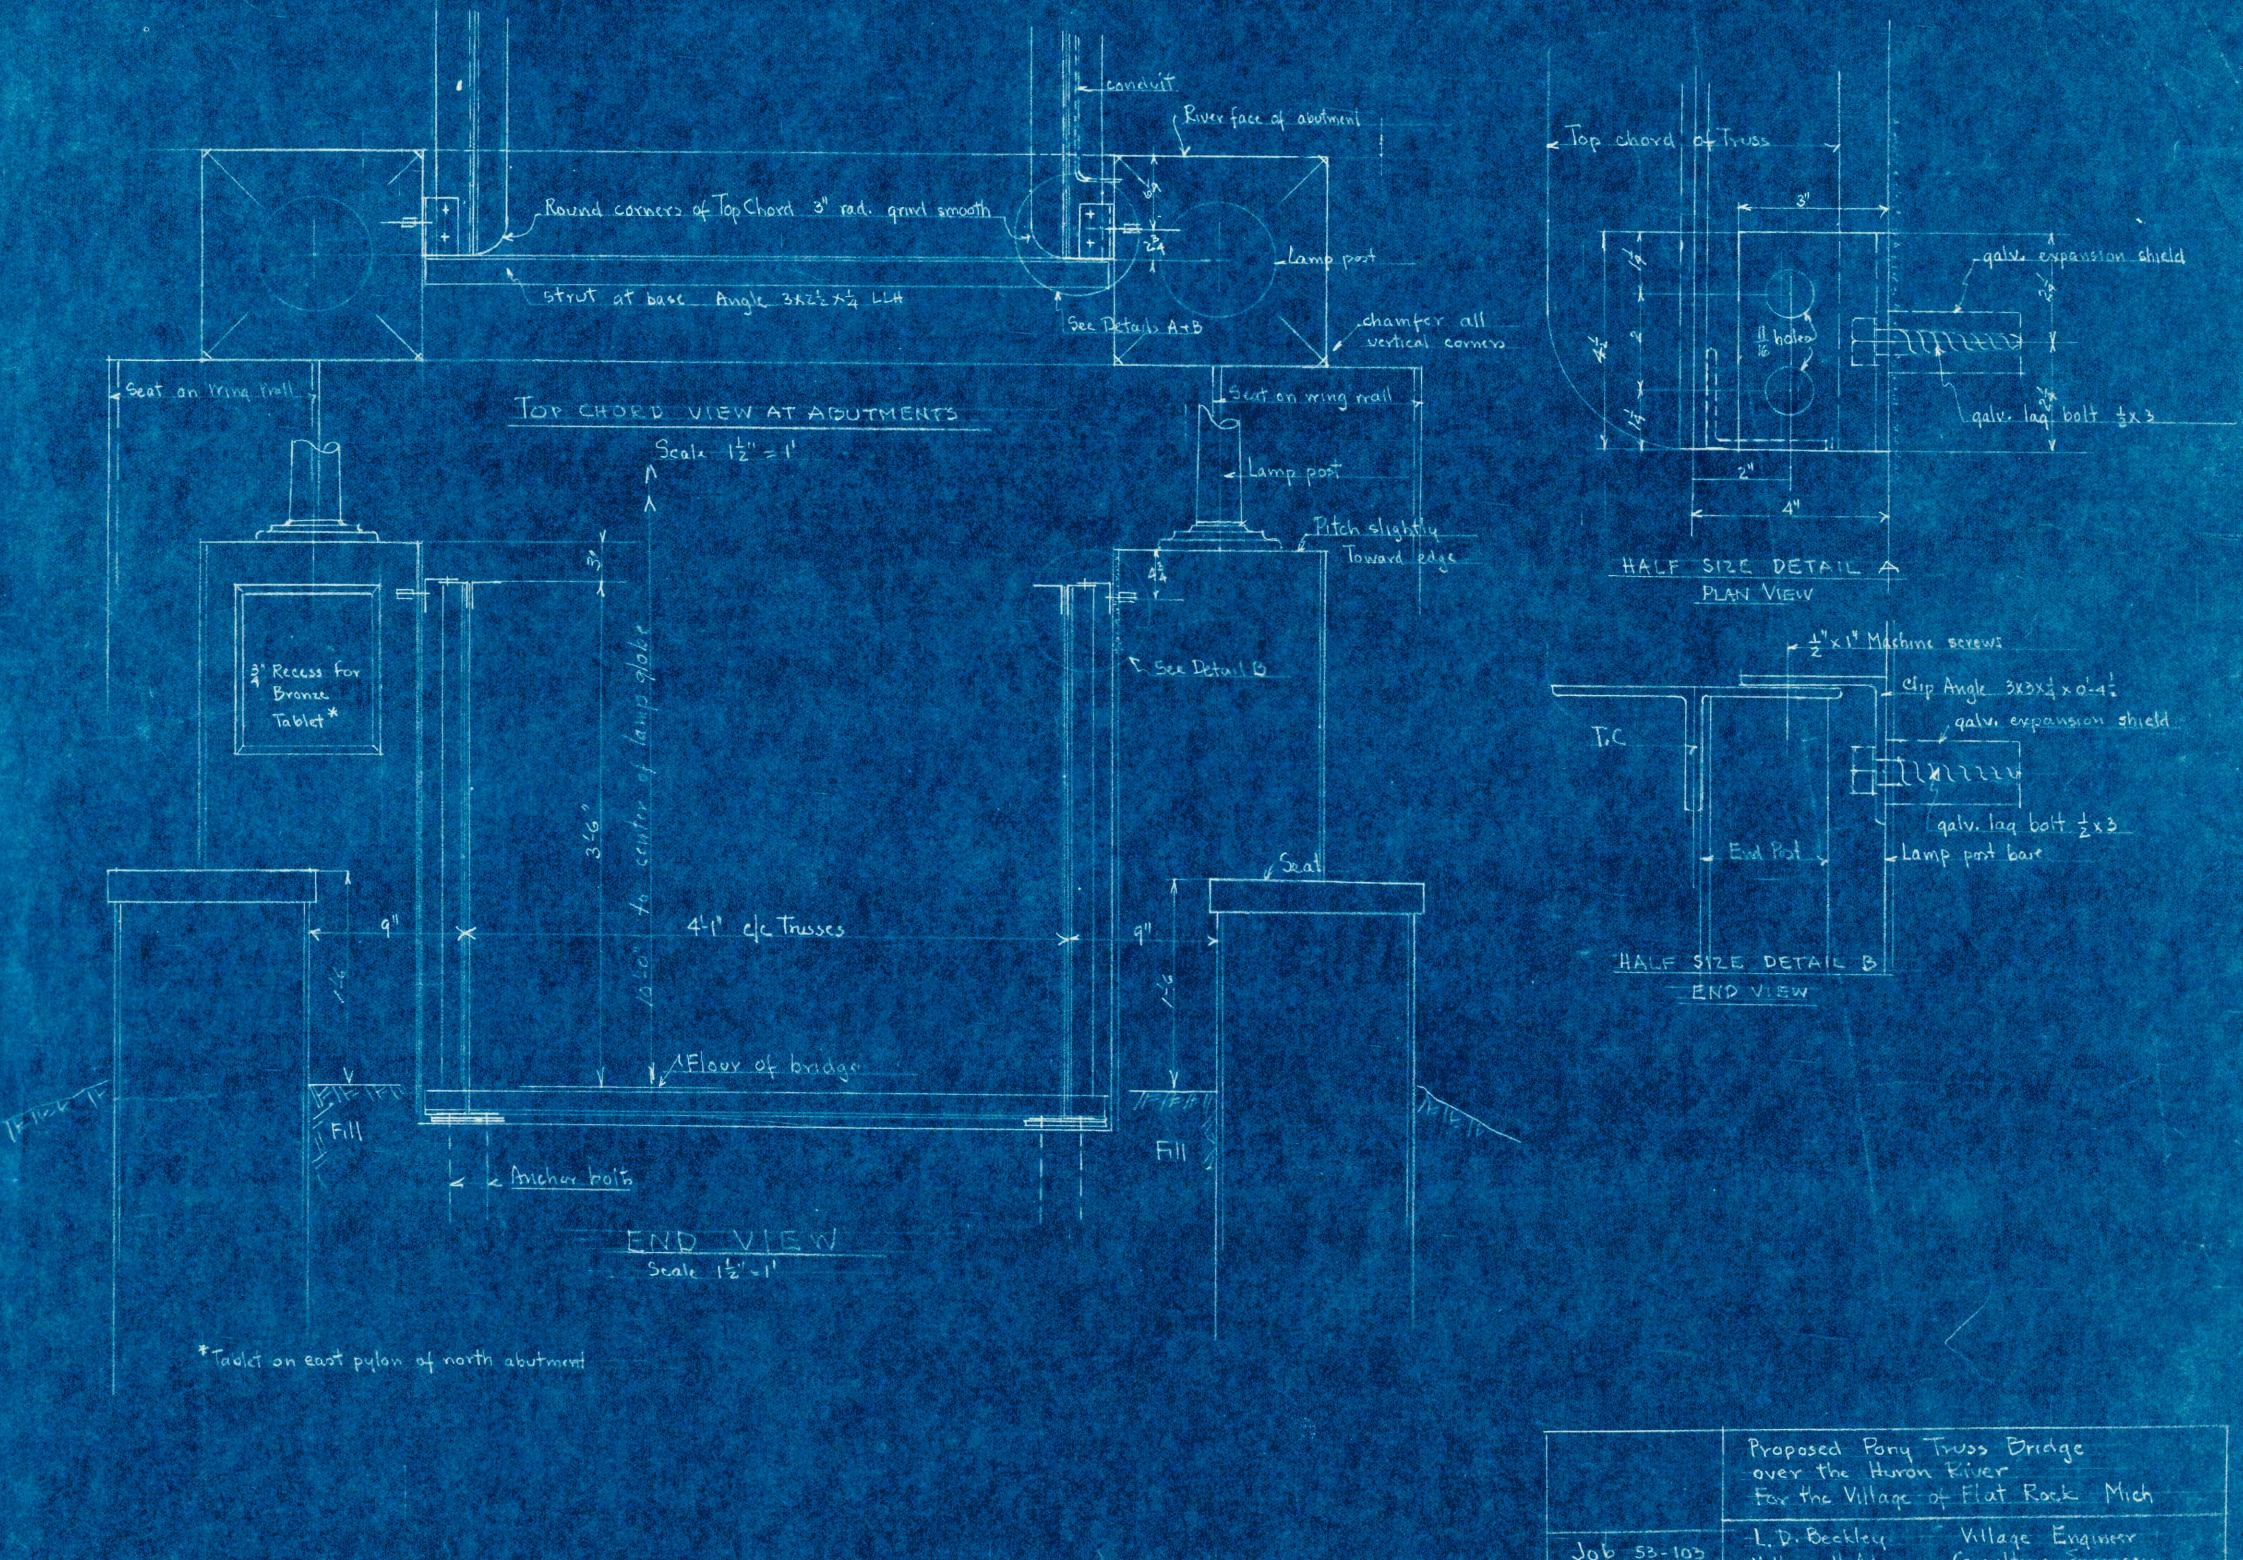



Job 53-103 William H Adams Consulting Engineer Sh 4

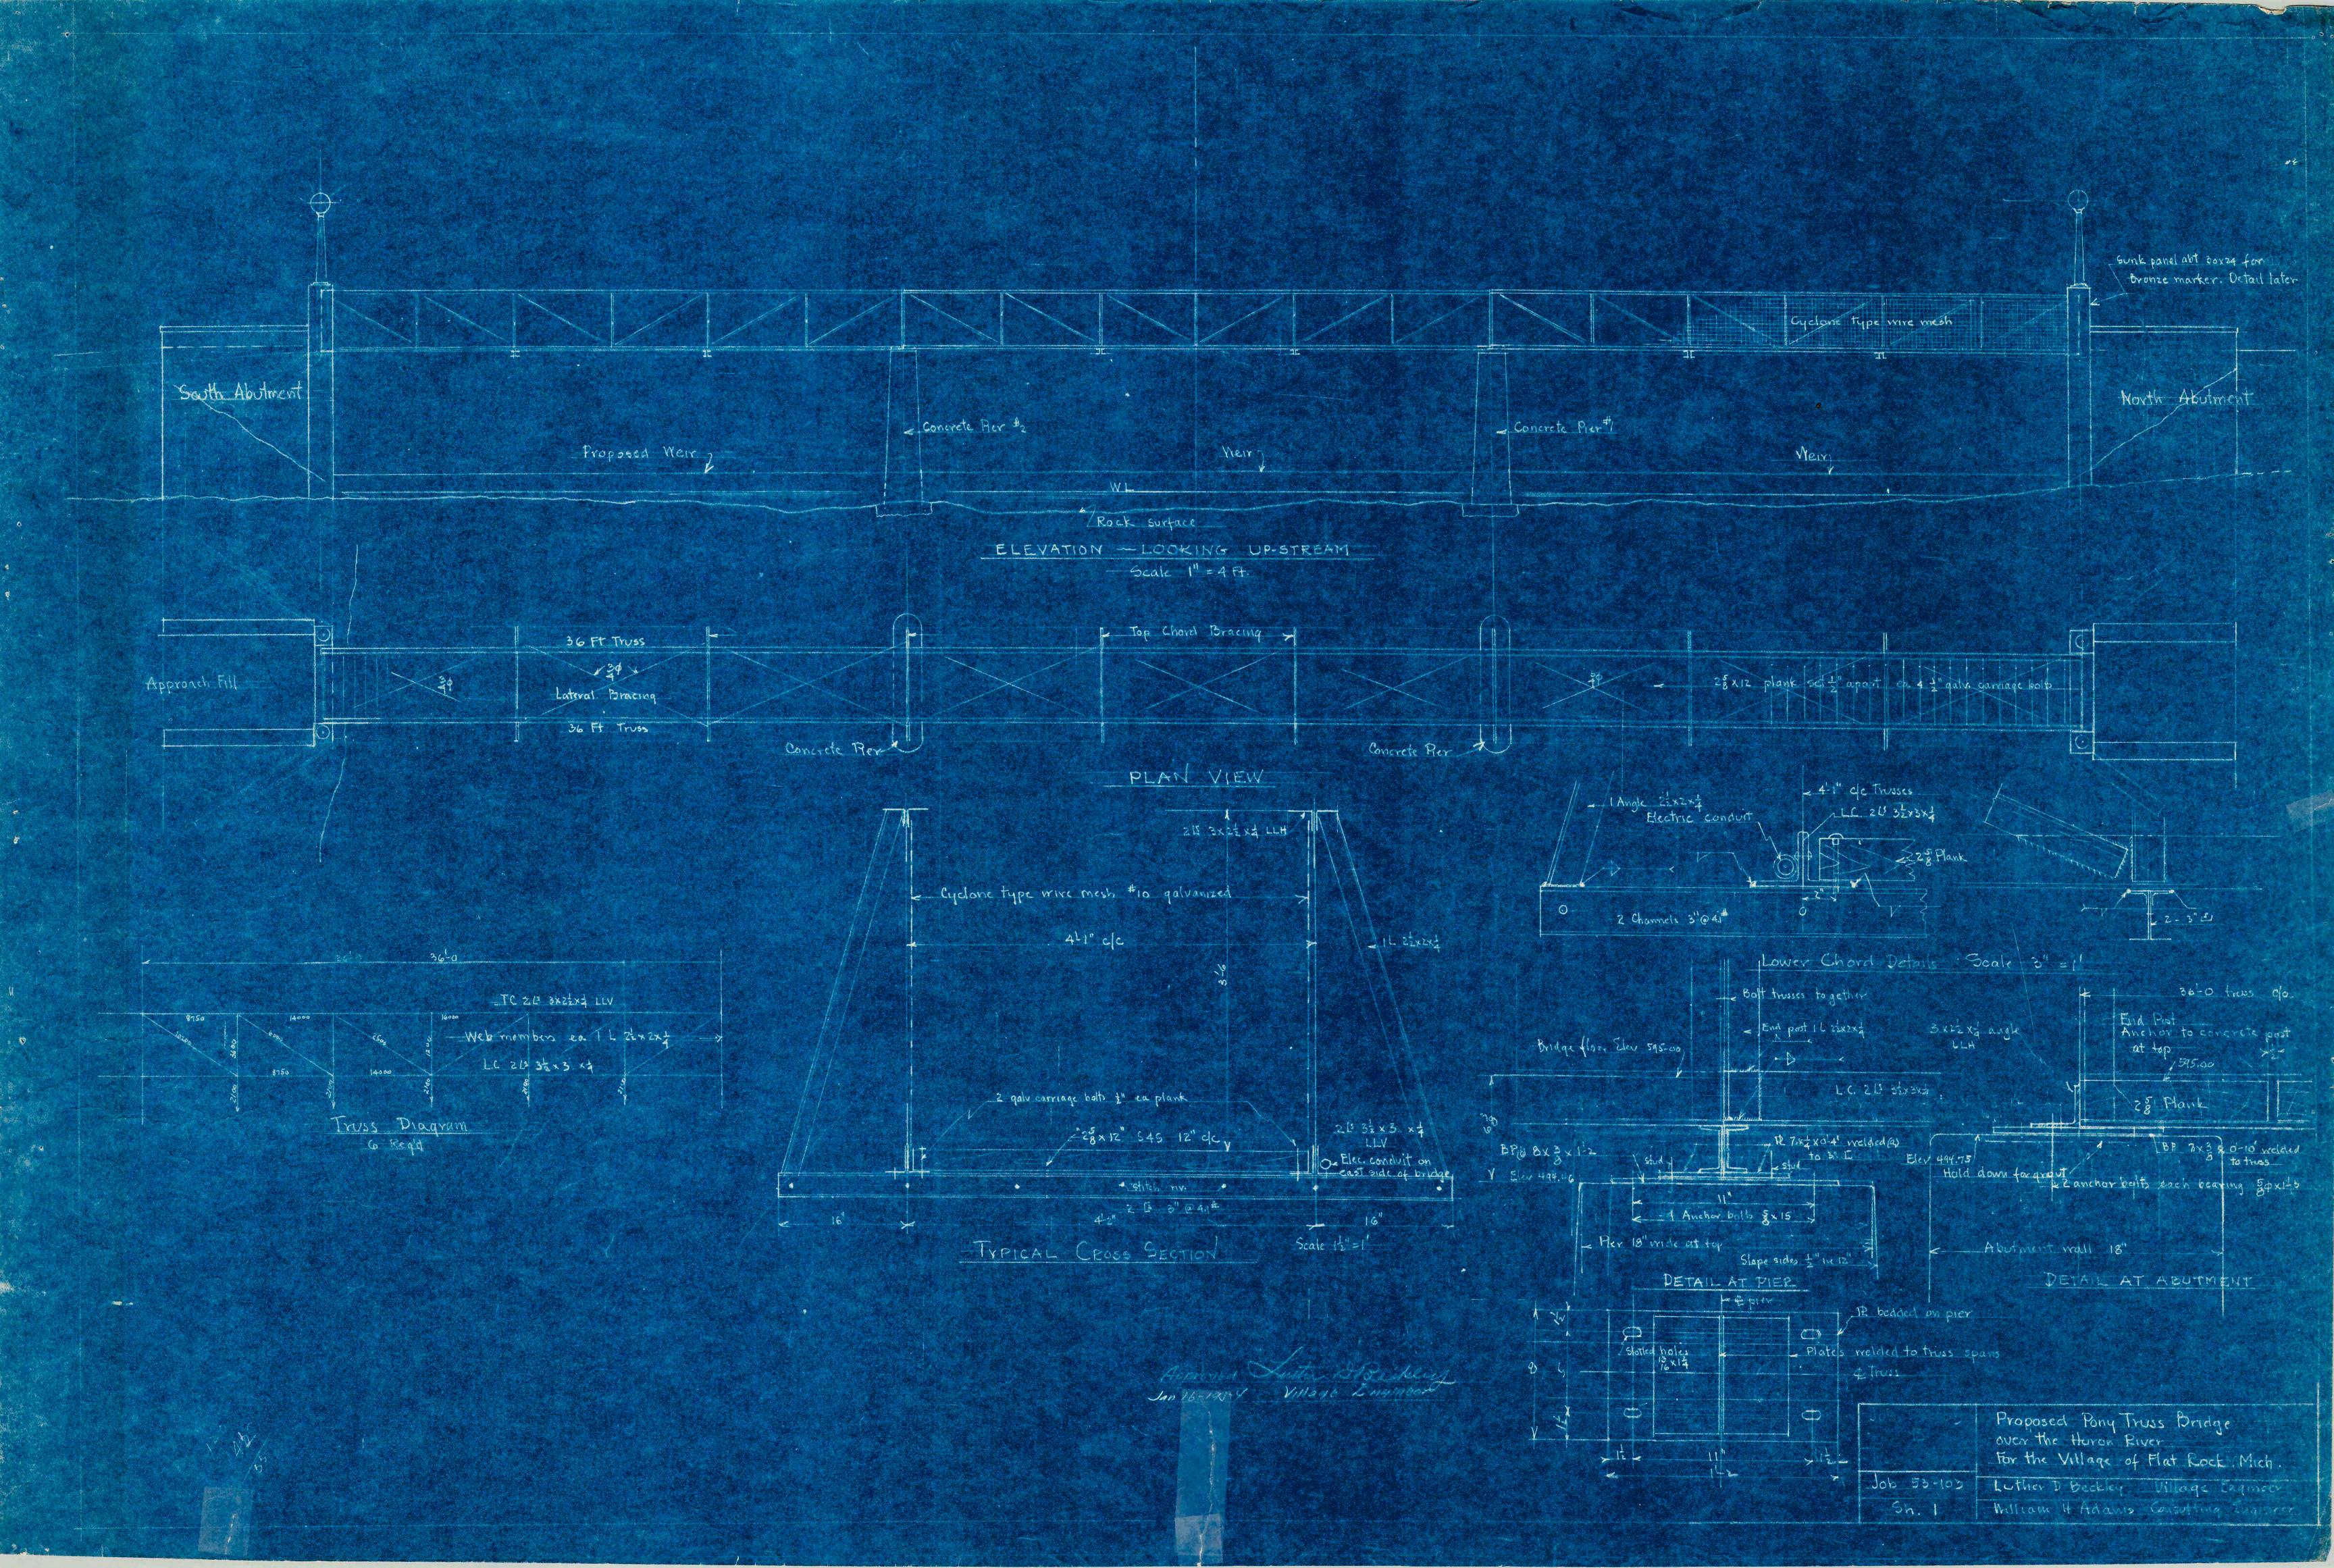


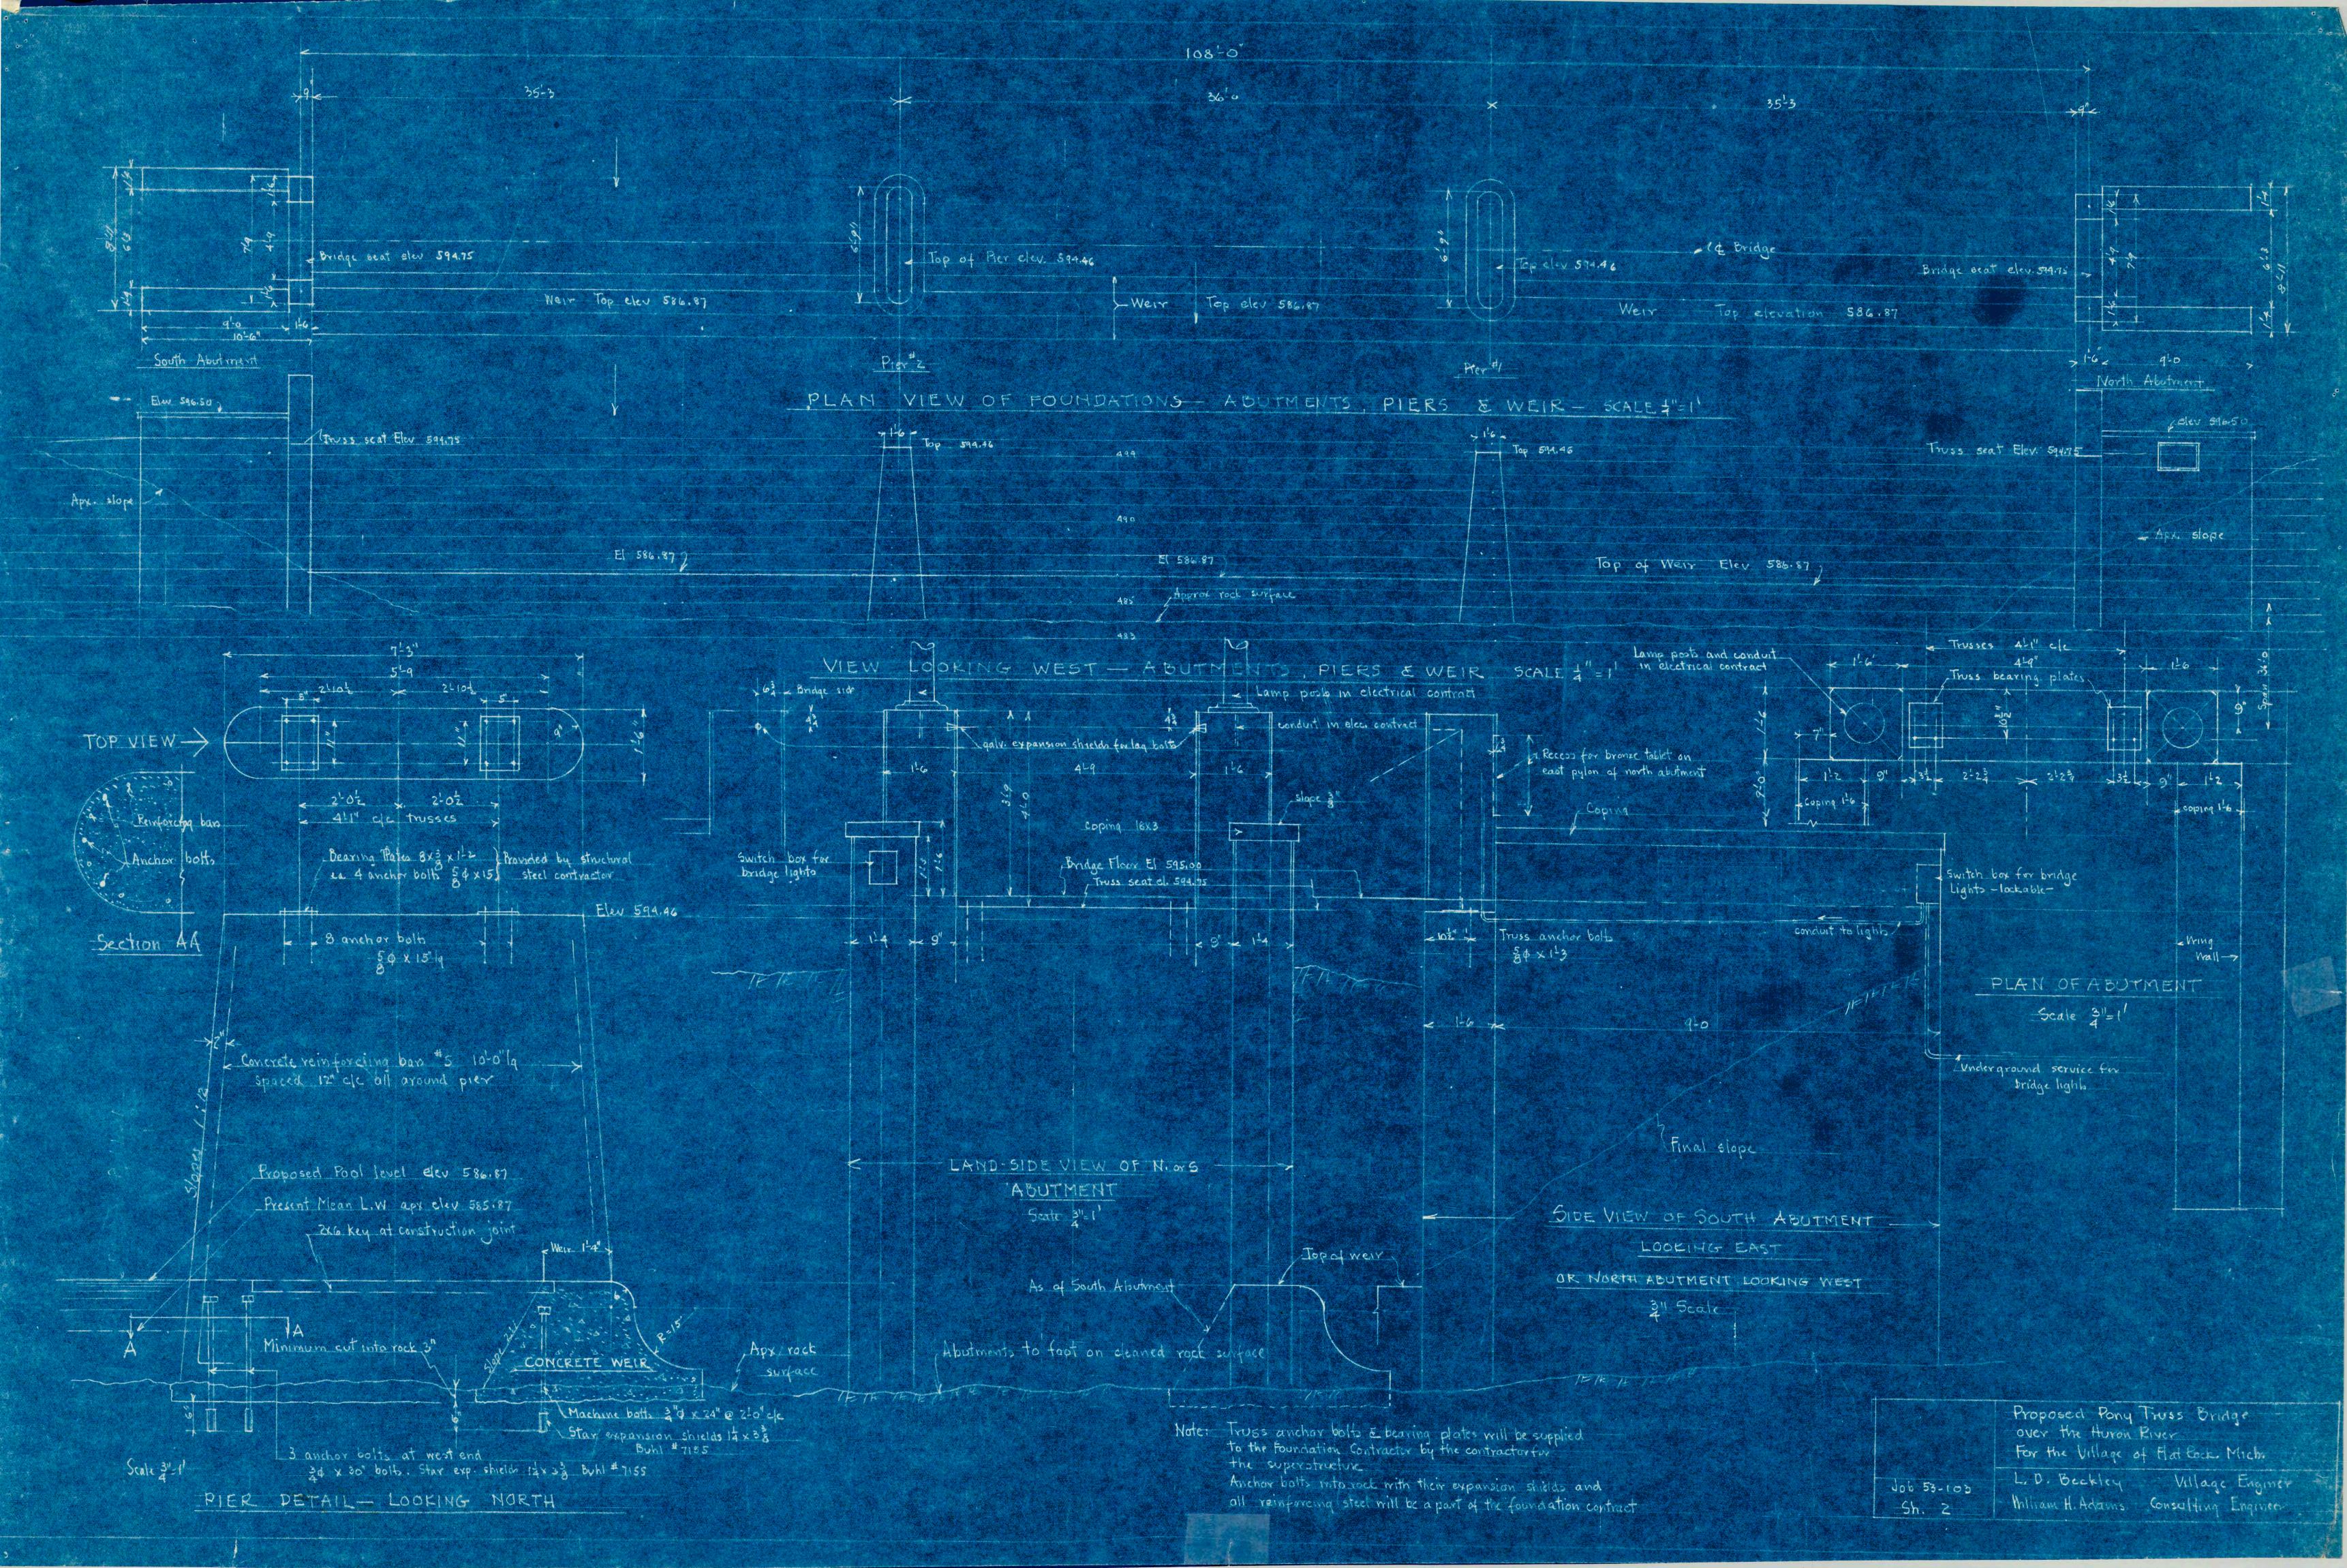

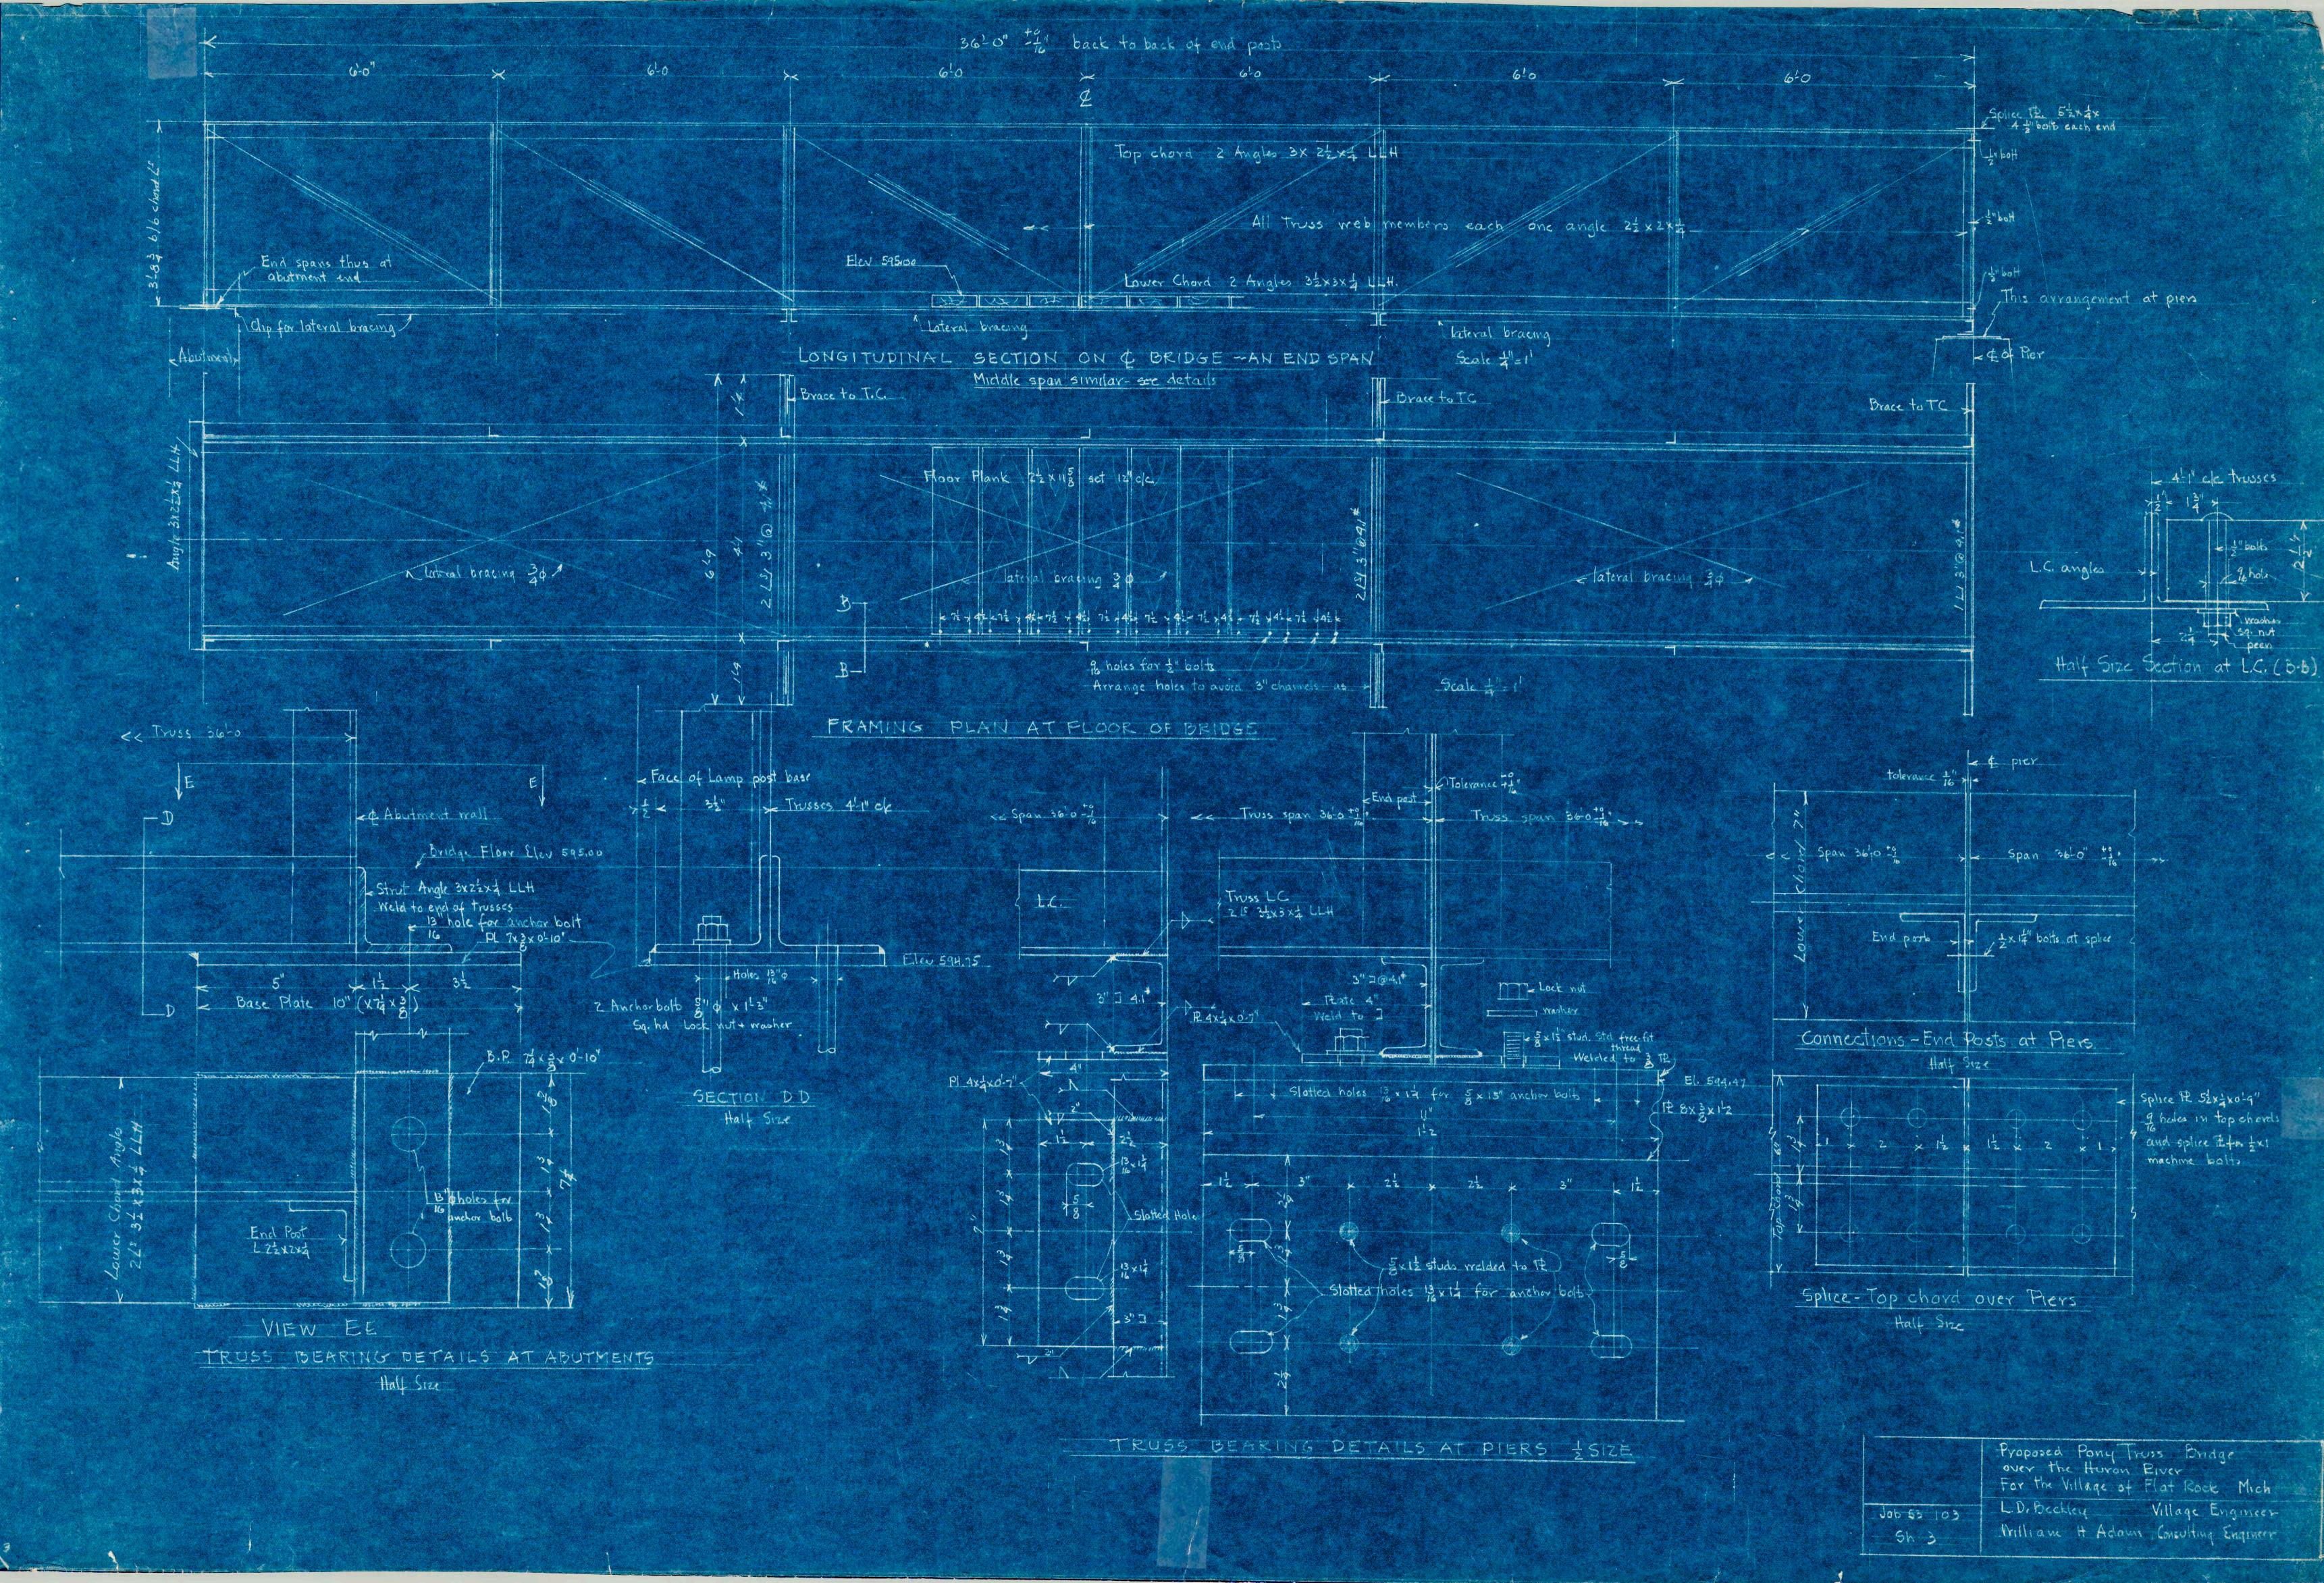

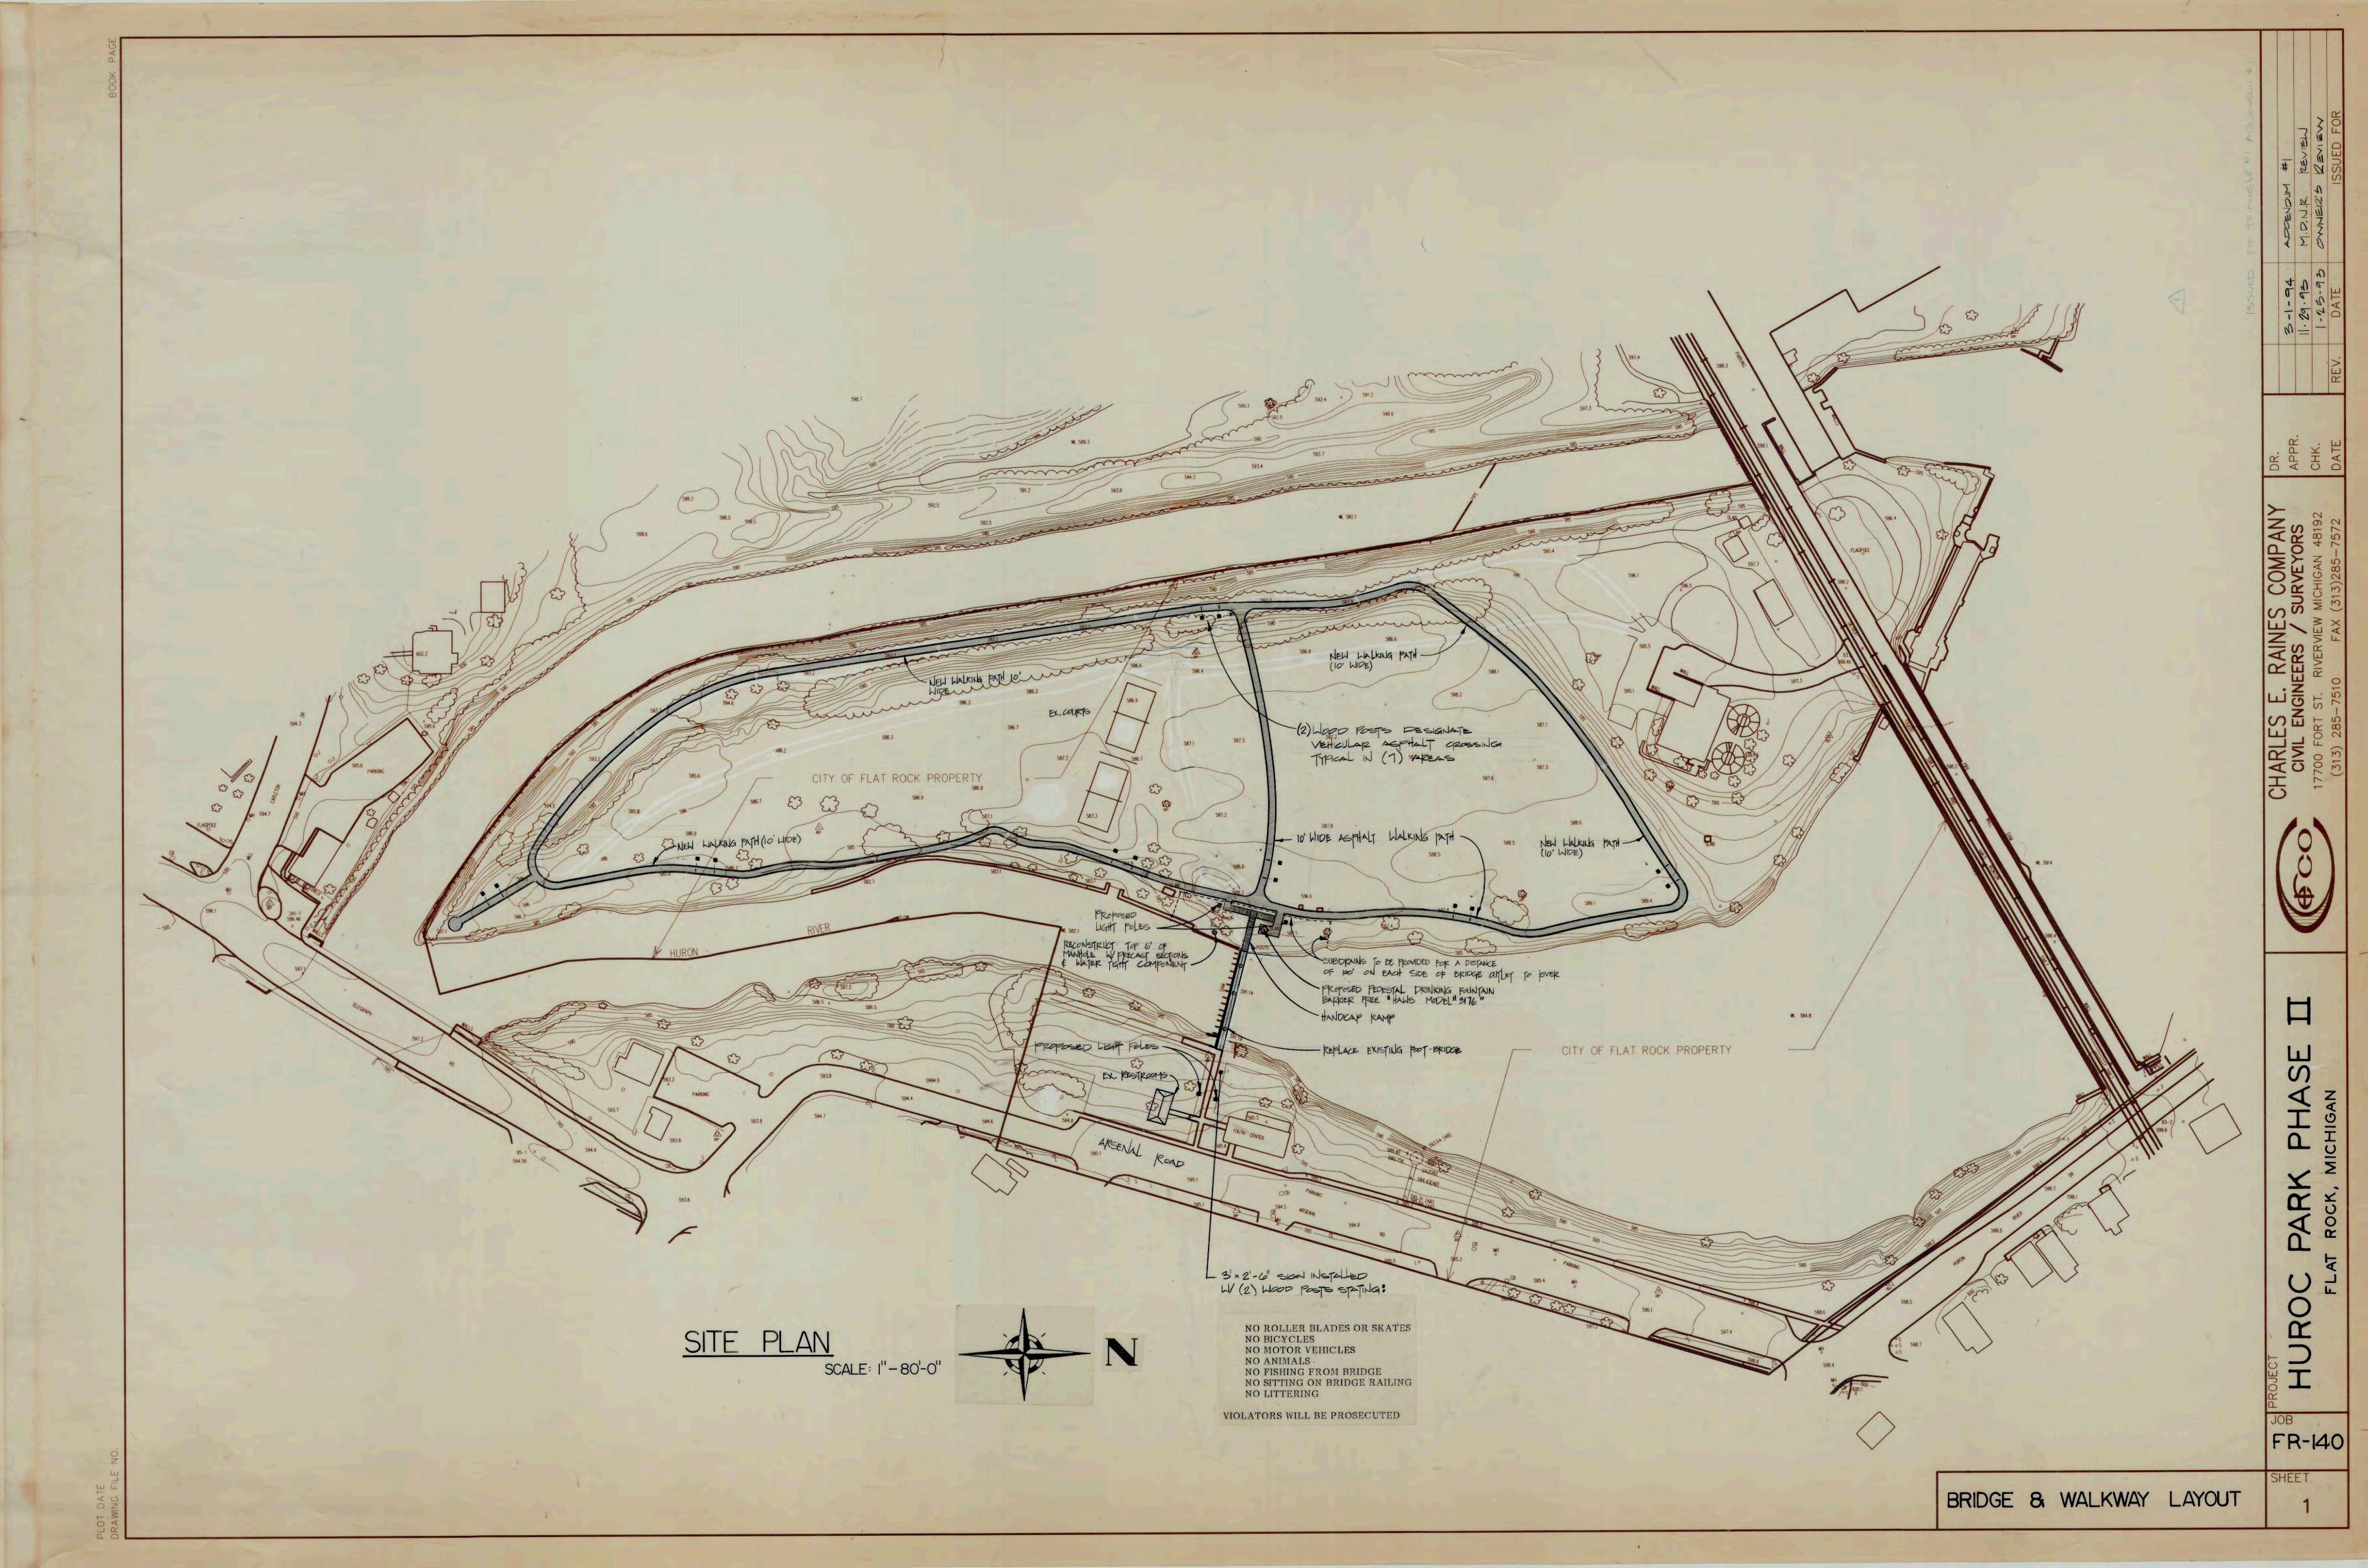

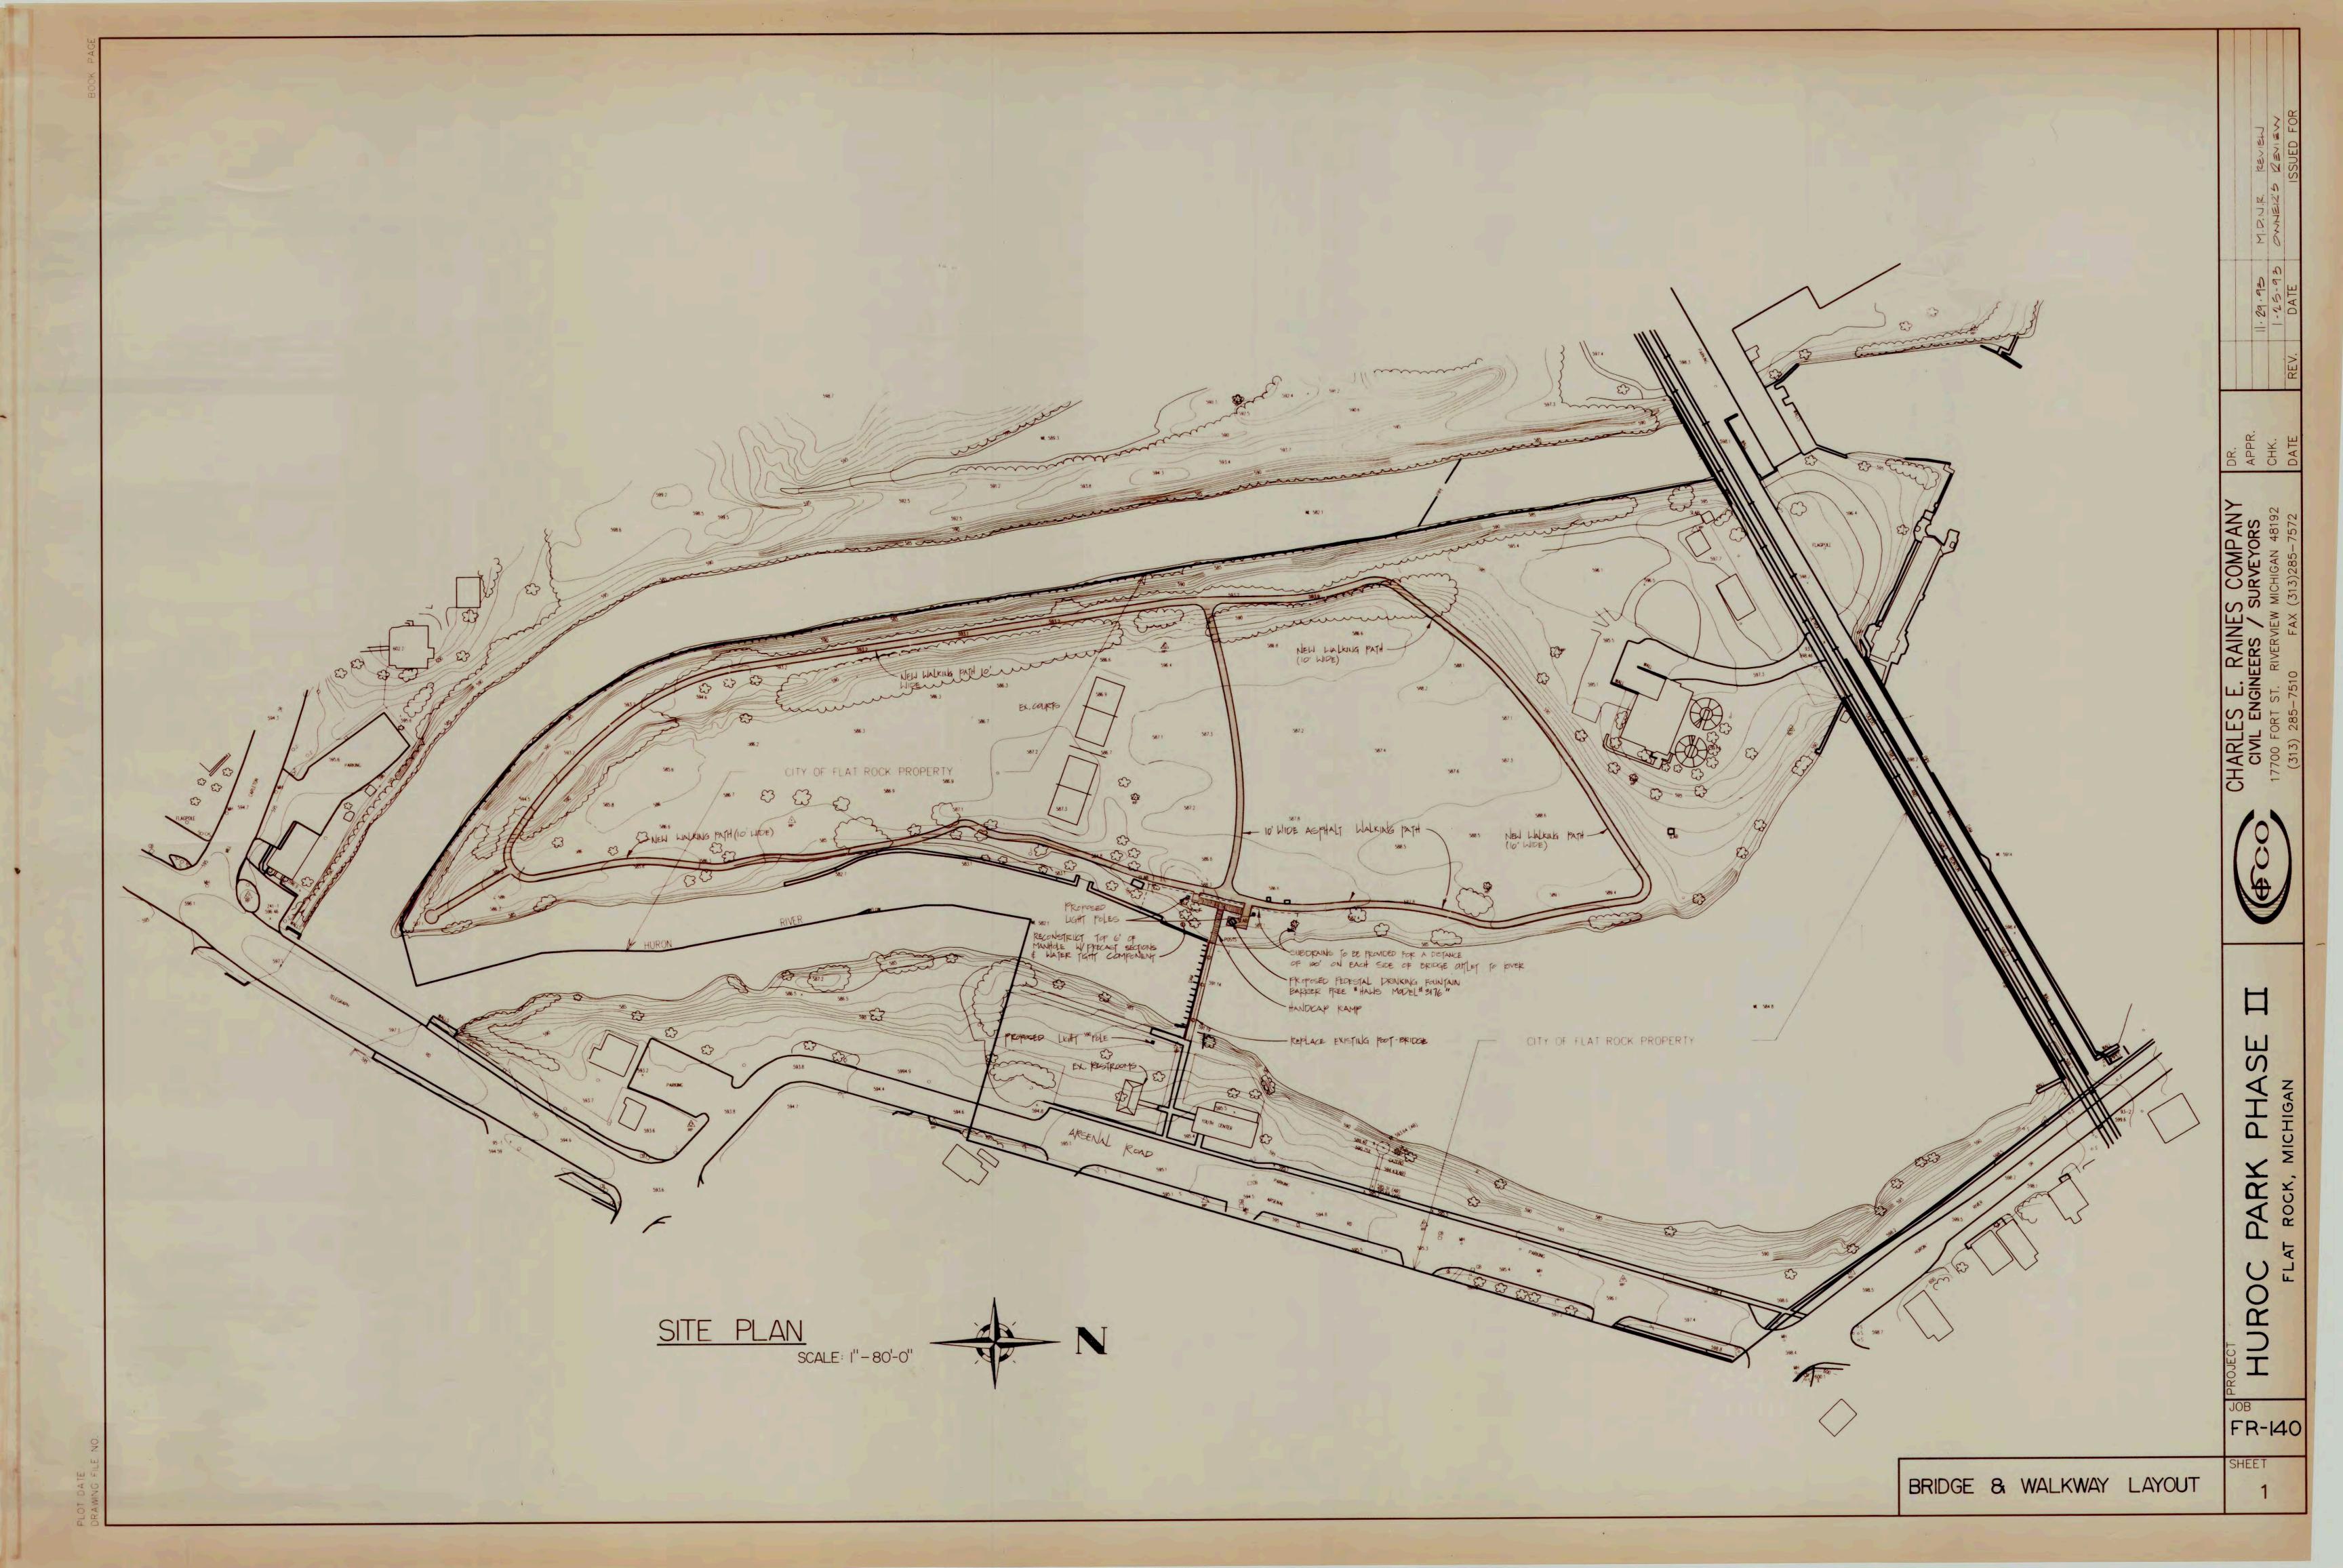

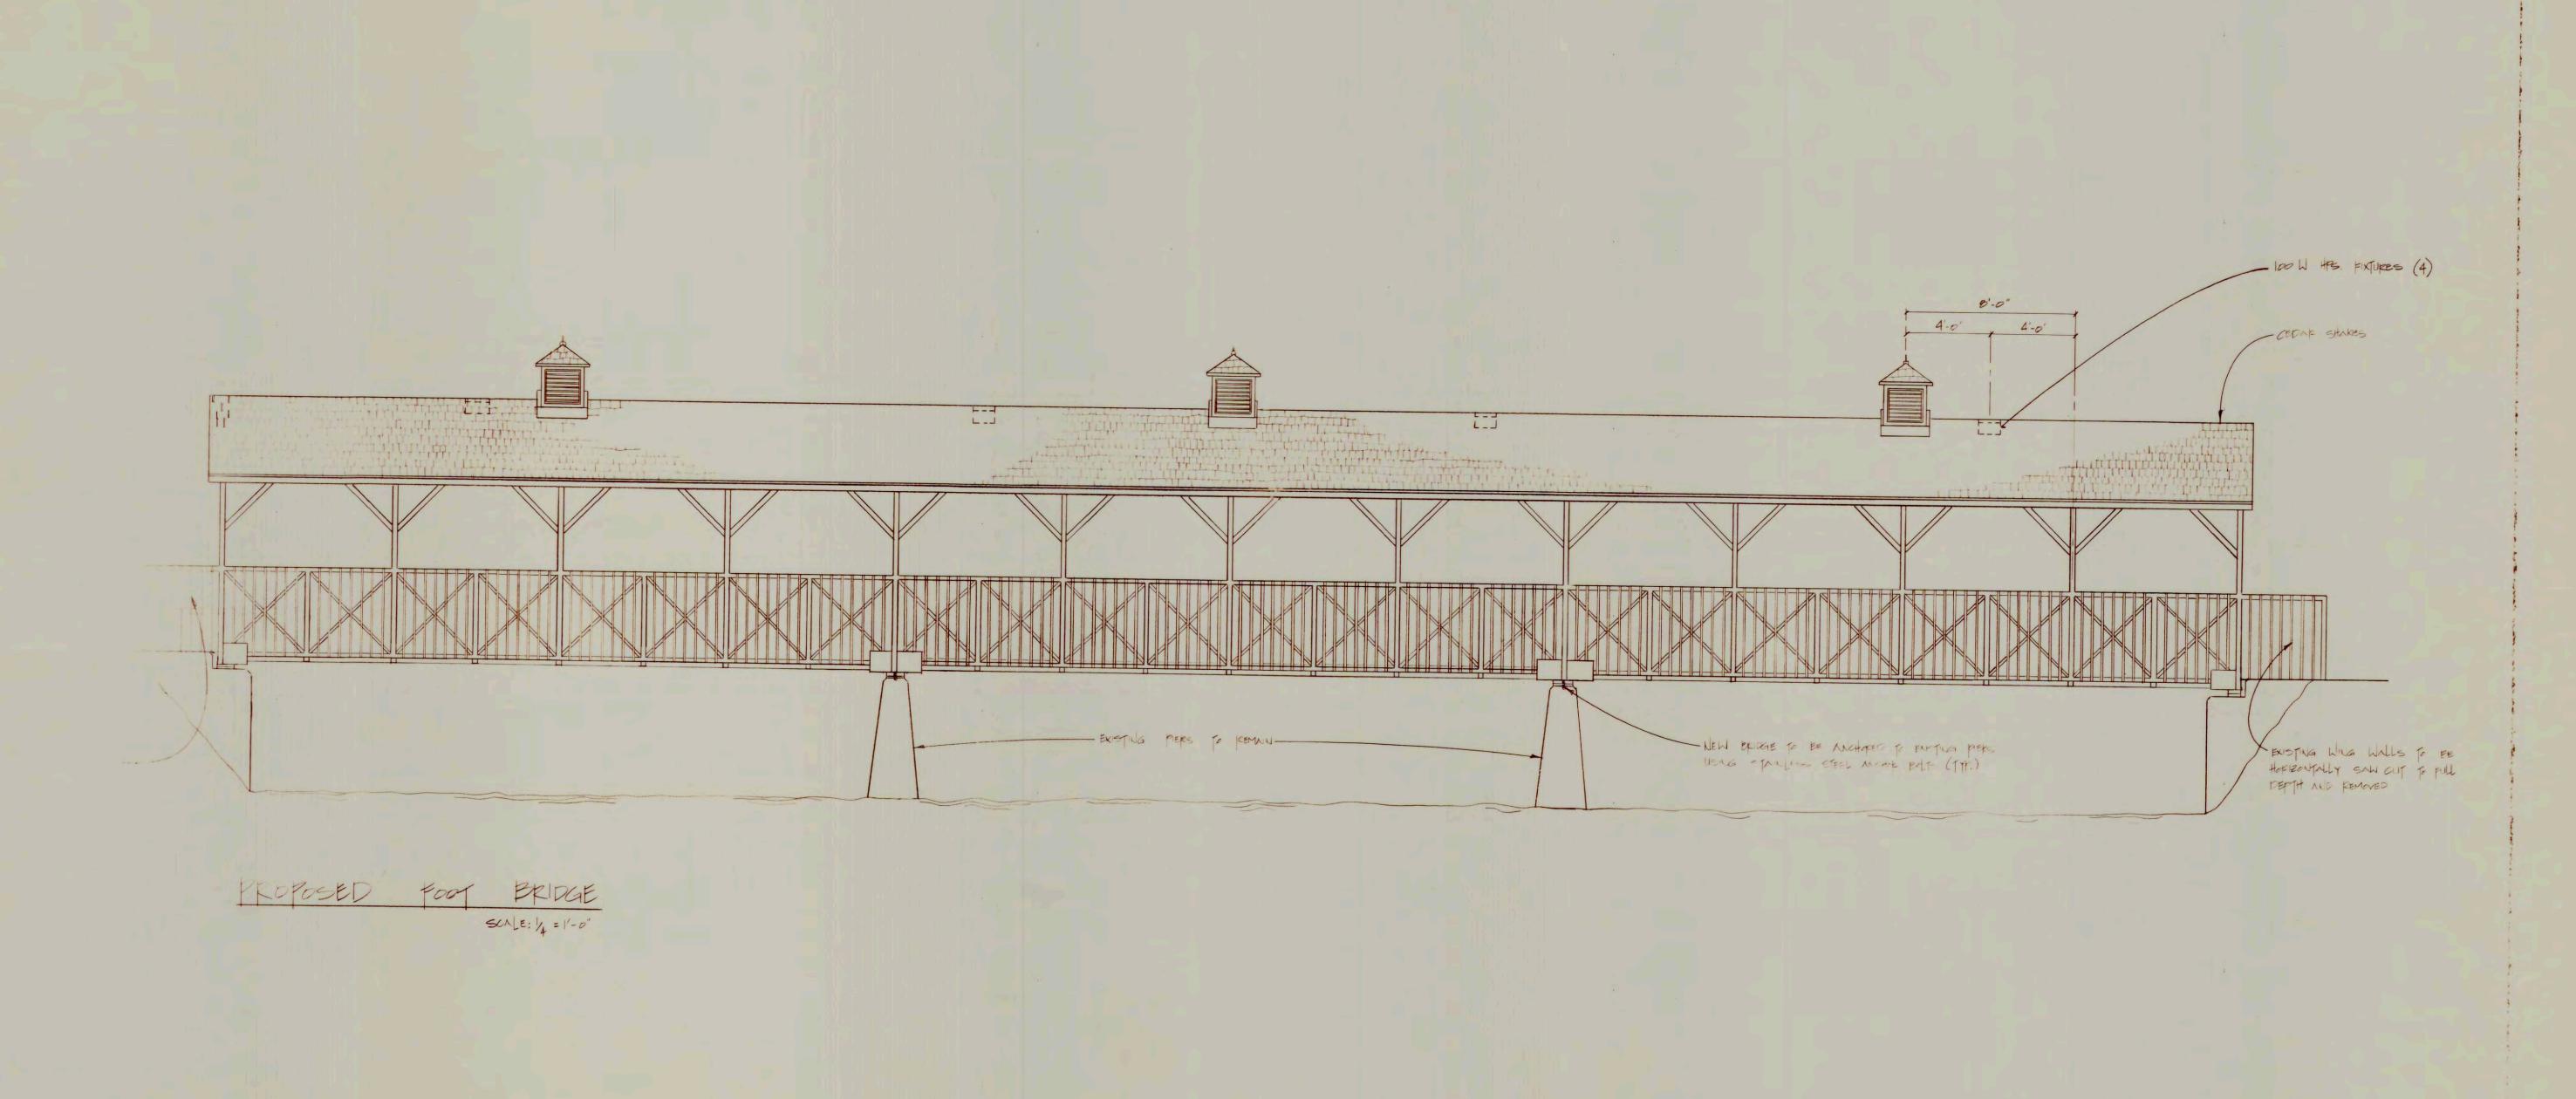

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